


**CONSTRUCTION OF MOTORIZED SHALLOW WELL -QOOQANE
VILLAGE -BELEDWEYNE DISTRICT-HIRSHABELLE STATE**

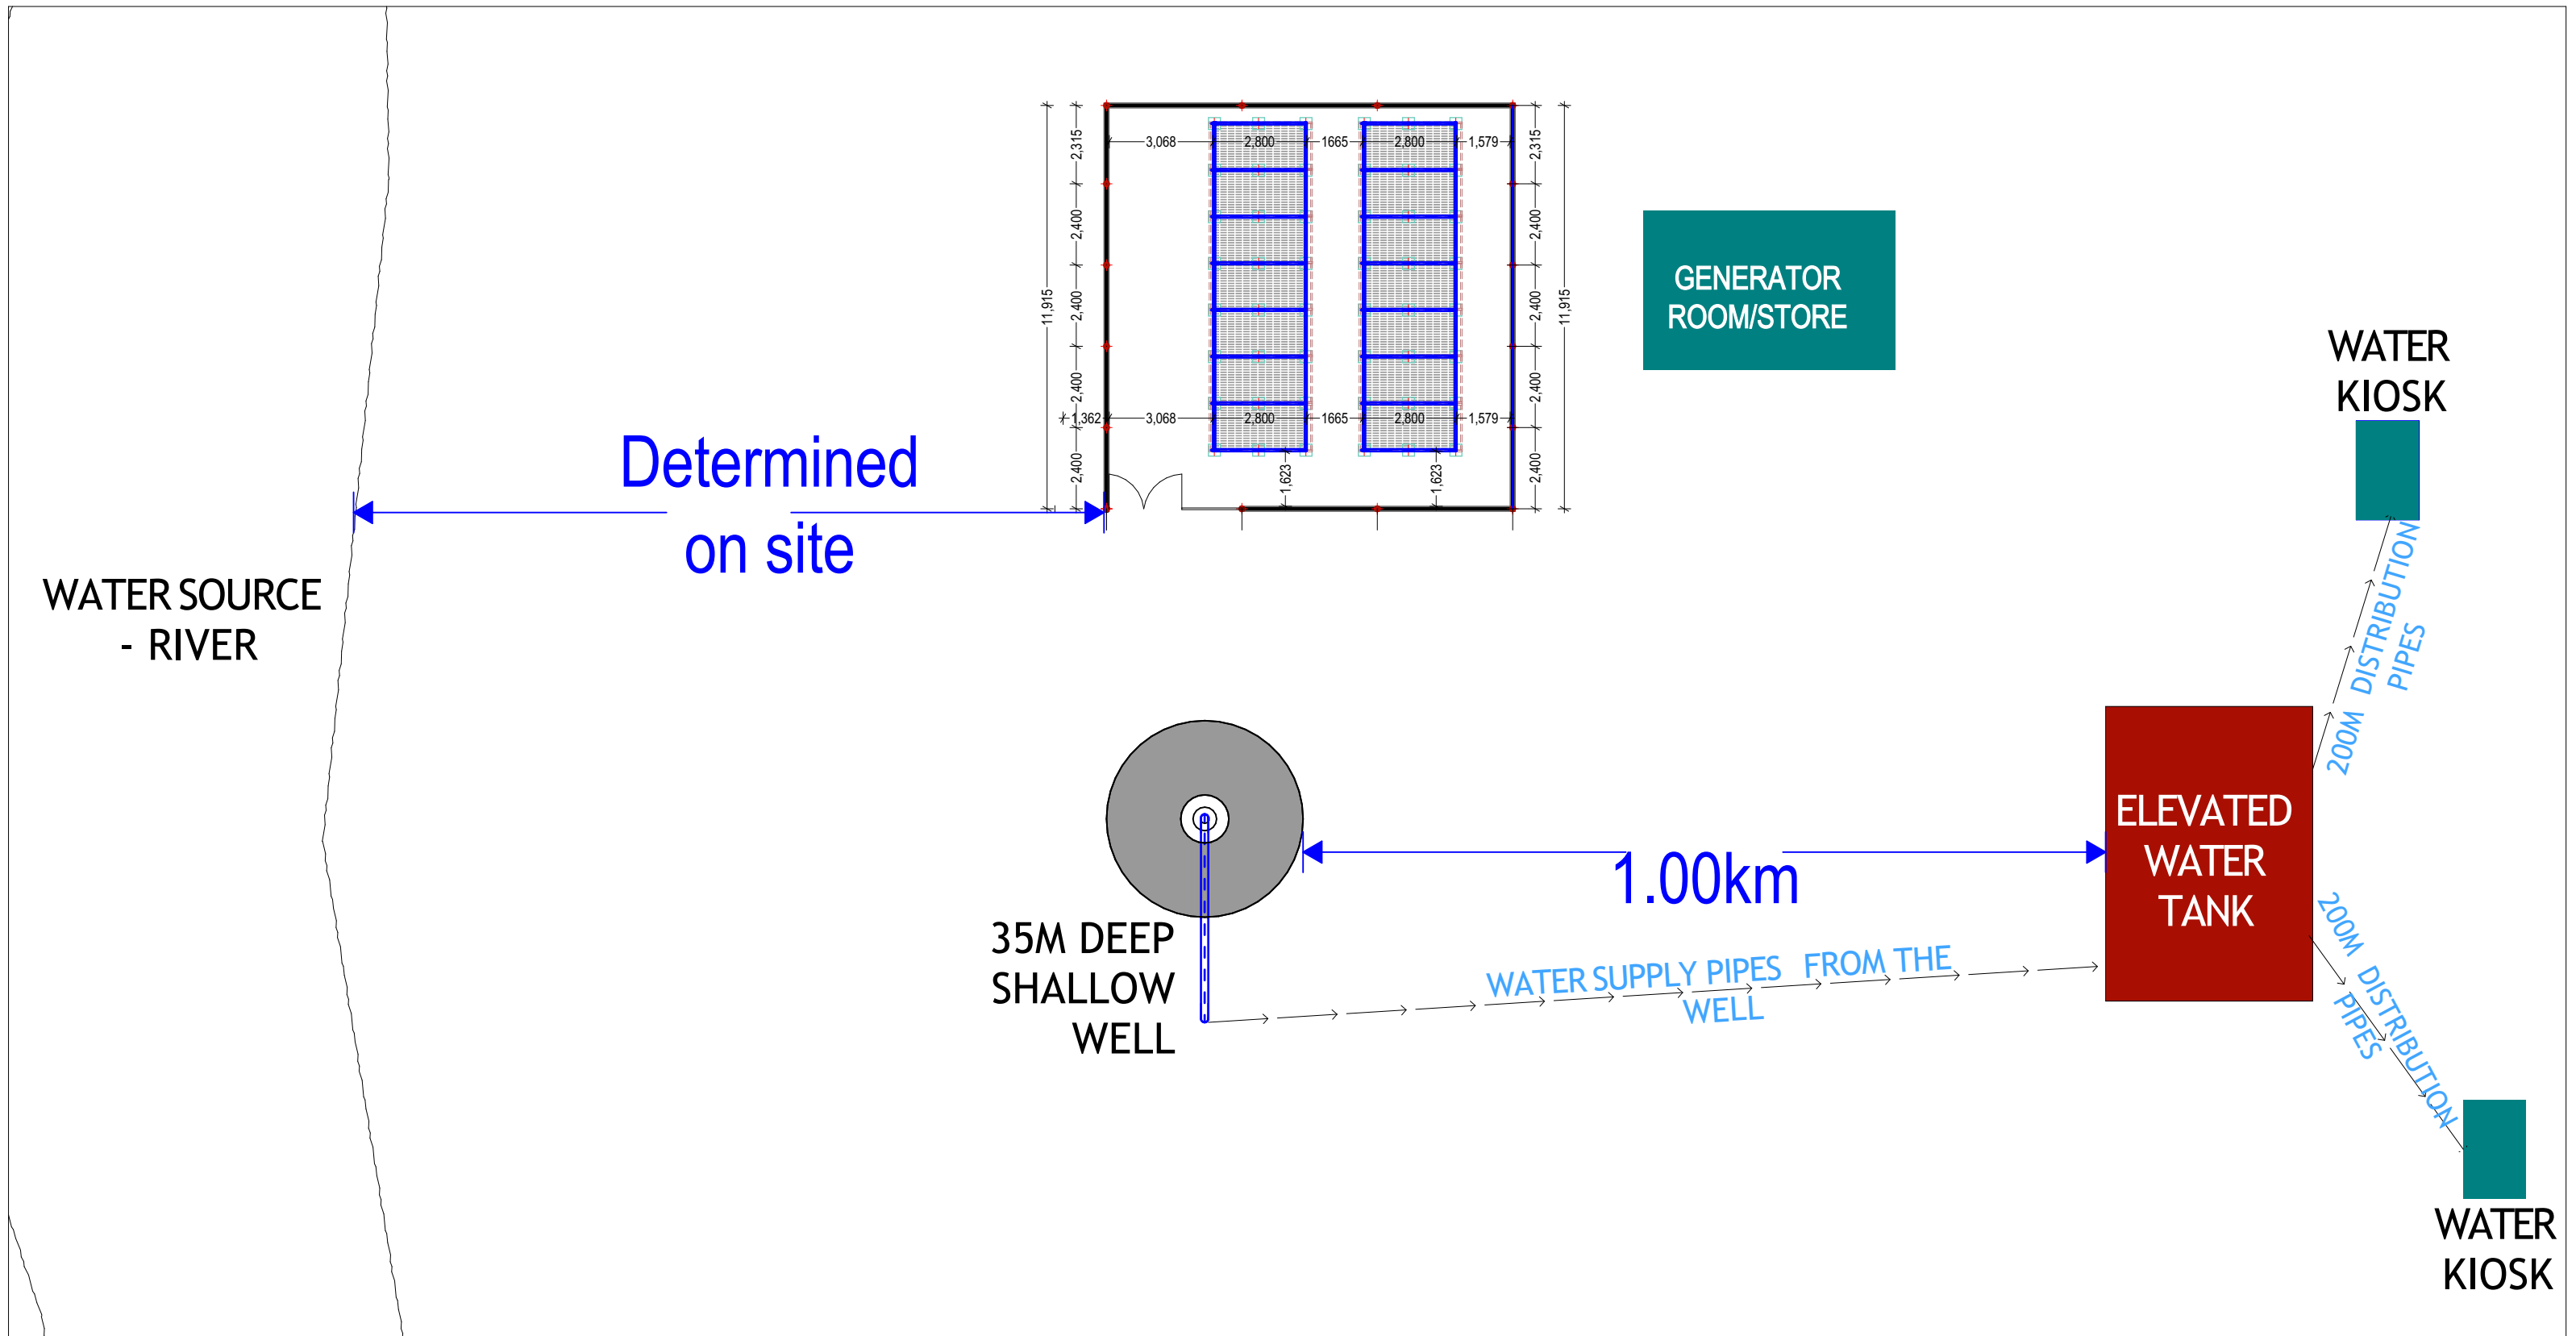

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PROJECT

EXCAVATION OF SHALLOW WELLS

IMPLEMENTING AGENCY



DEPARTMENT

WATER SANITATION AND HYGIENE
WASH

SCALE	
DATE	NOV 2020
DESIGNED BY:	ENG. Wanja.D
DRAWN BY:	ENG. Wanja.D
REVIEWED BY:	
APPROVED BY:	




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
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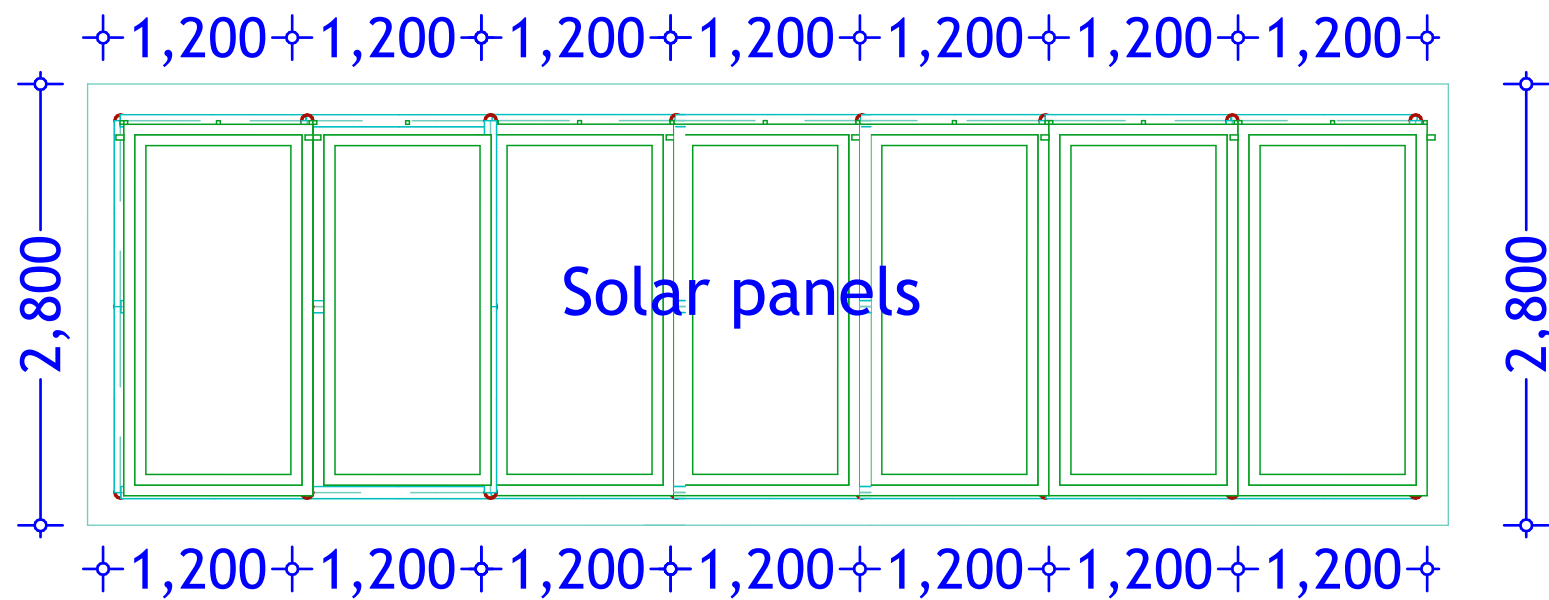
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SITE PLAN


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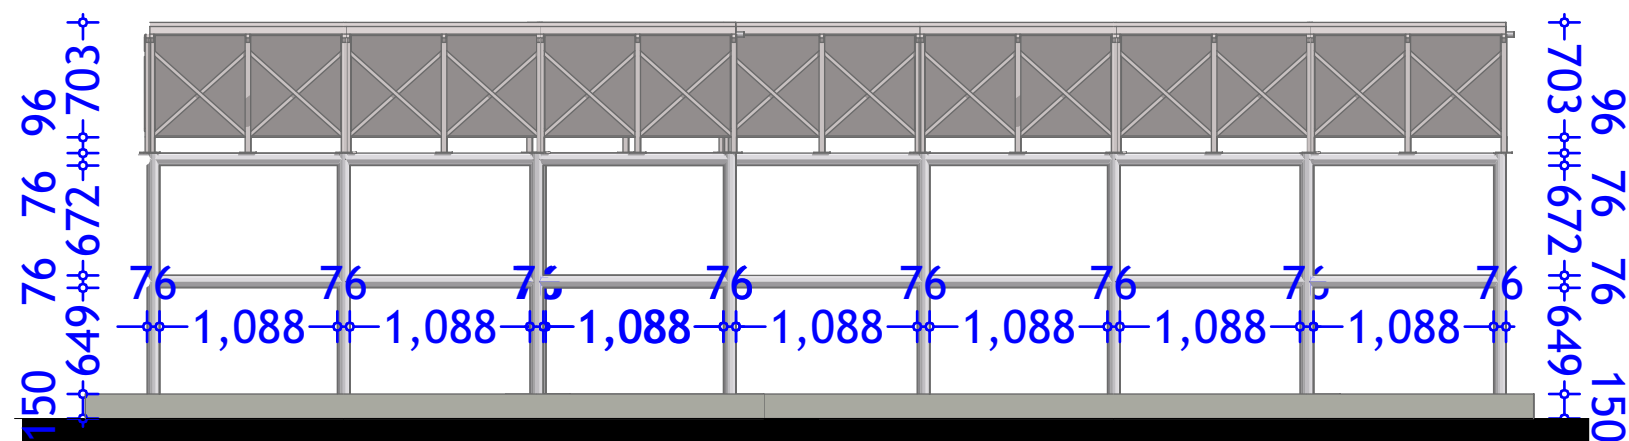
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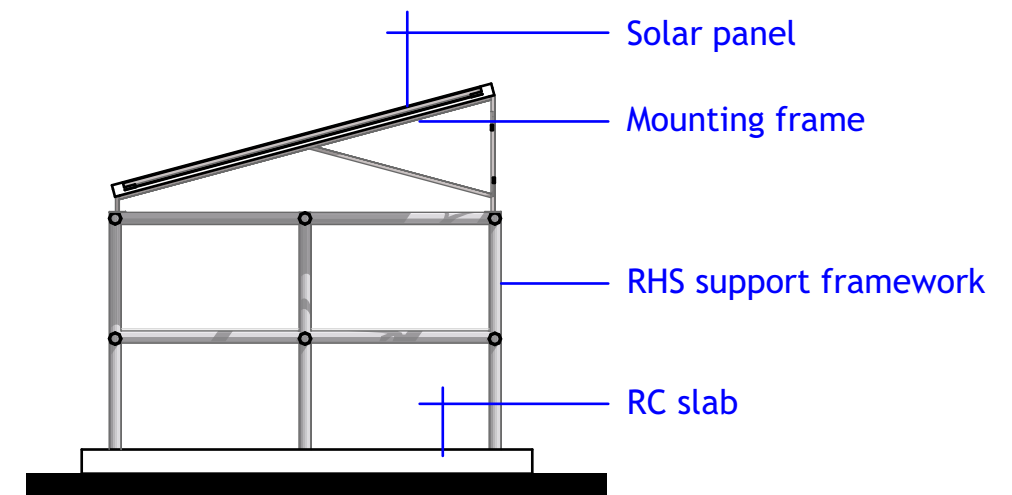
TYPICAL 7 NO. PANEL LAYOUT



SOLAR STRUCTURE ELEVATION

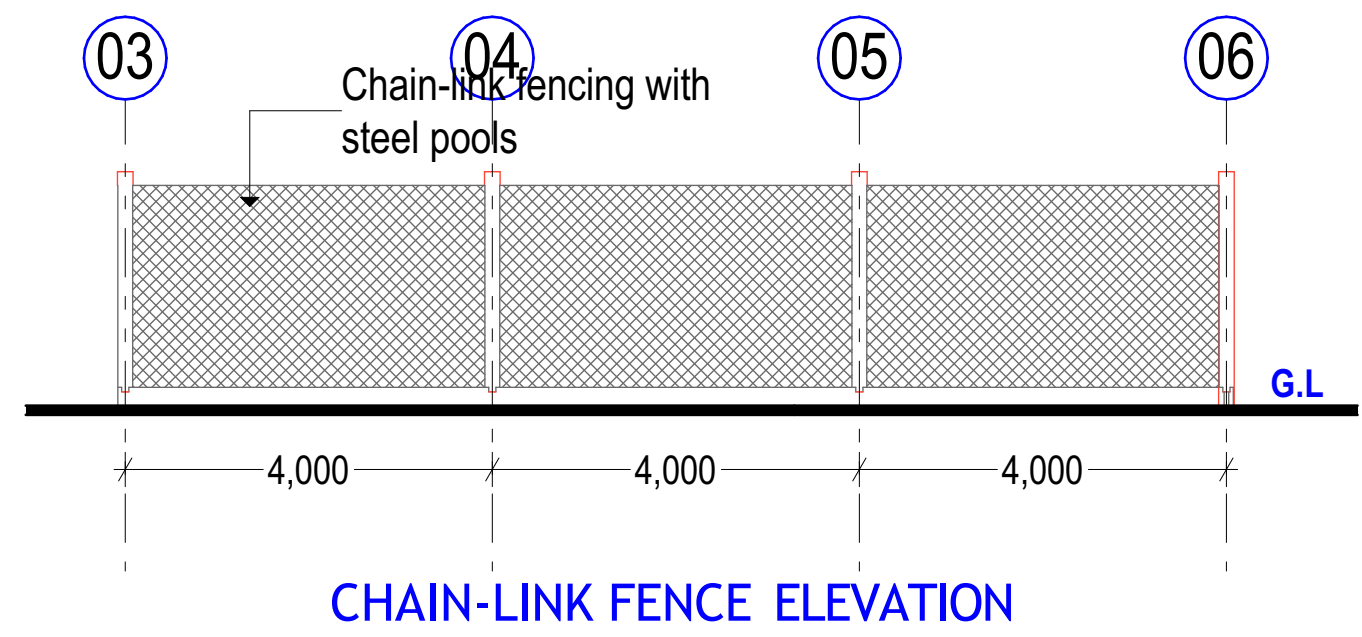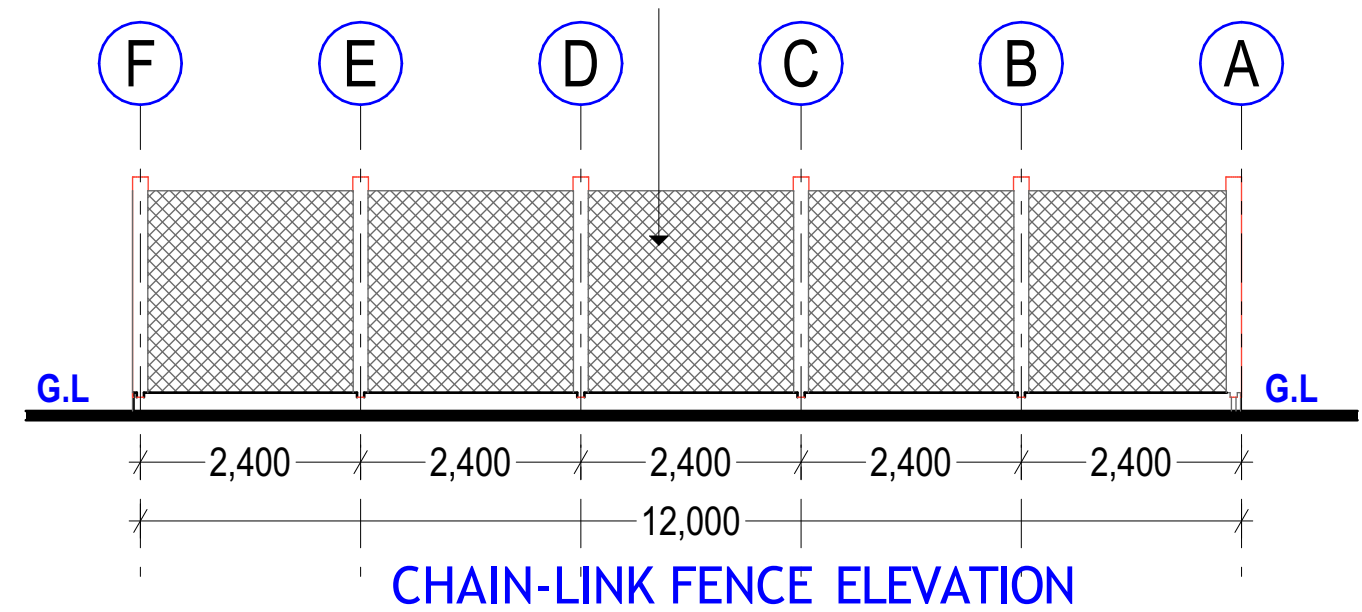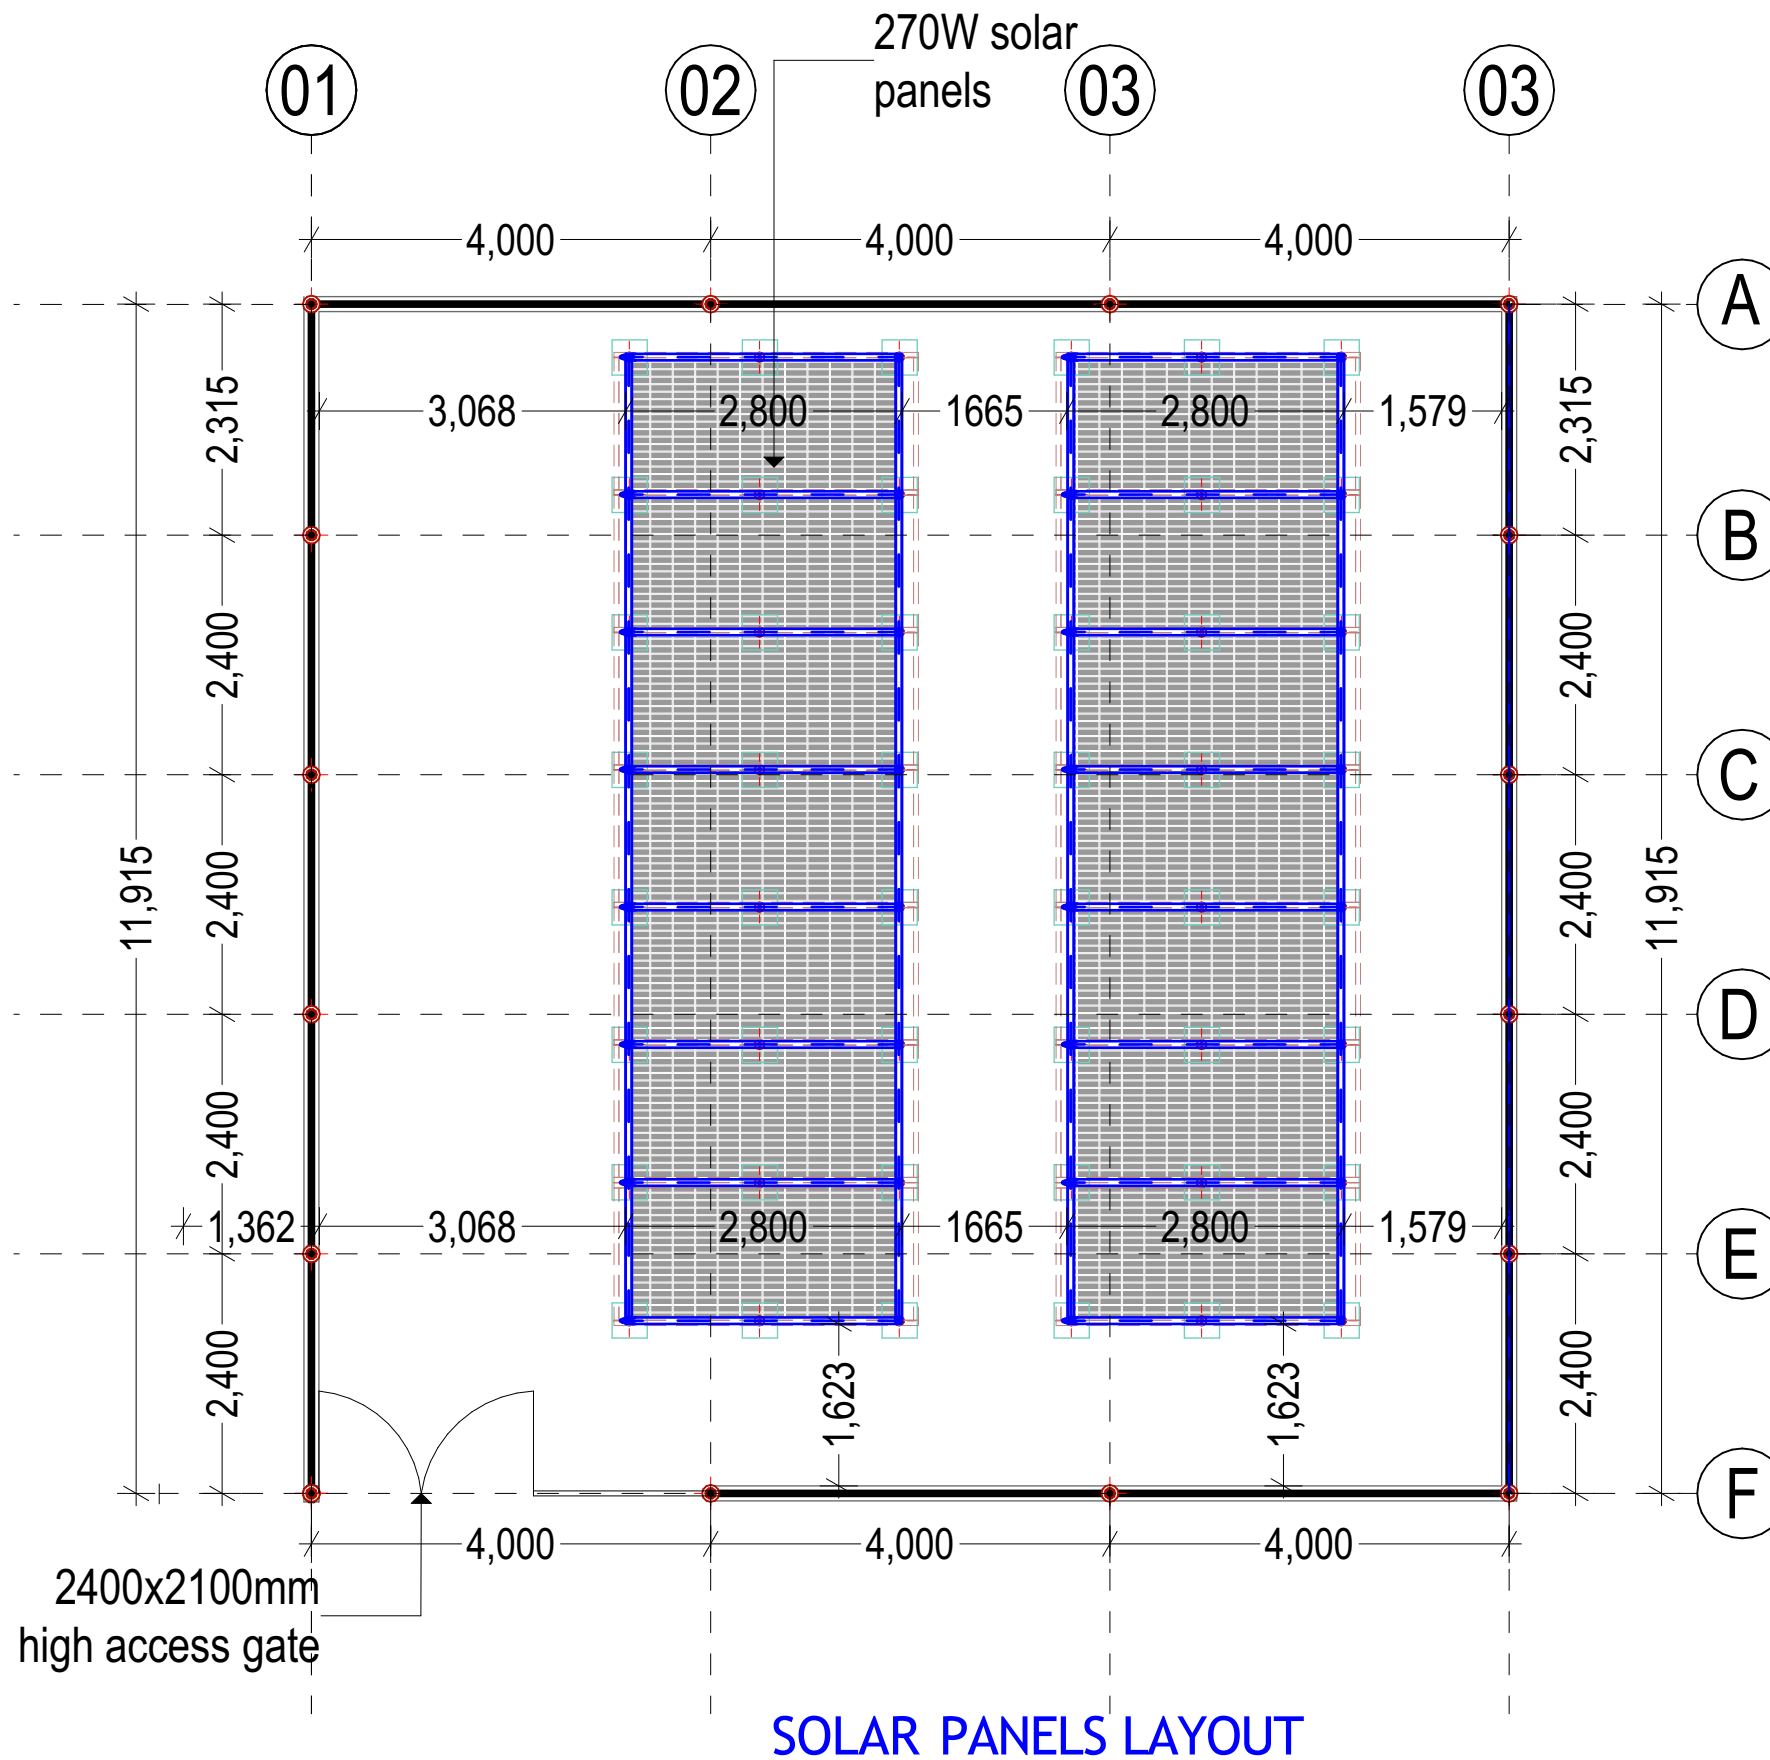

SOLAR STRUCTURE ELEVATION

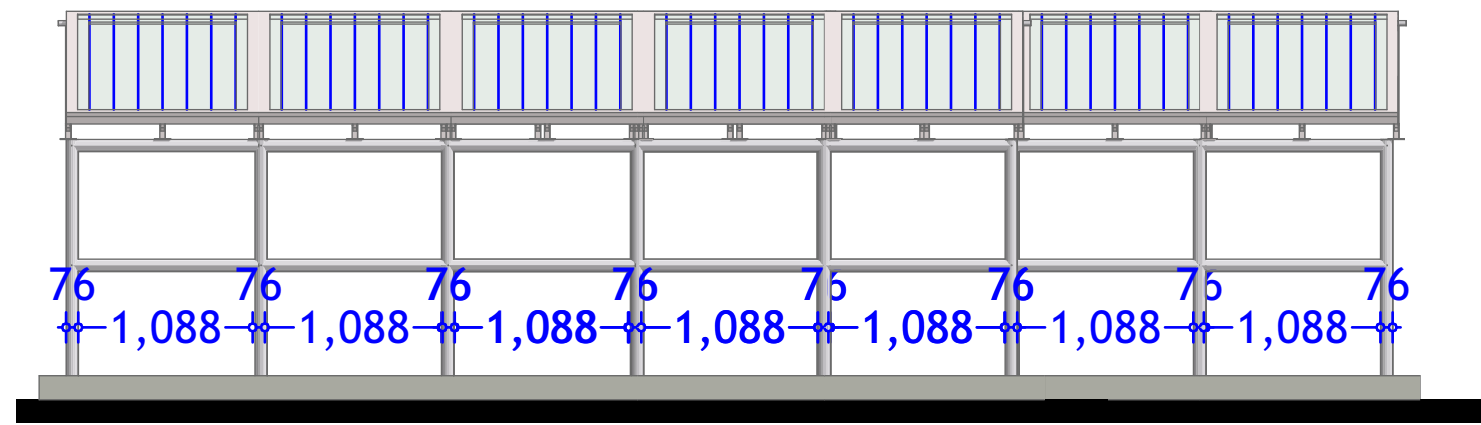

SOLAR STRUCTURE ELEVATION

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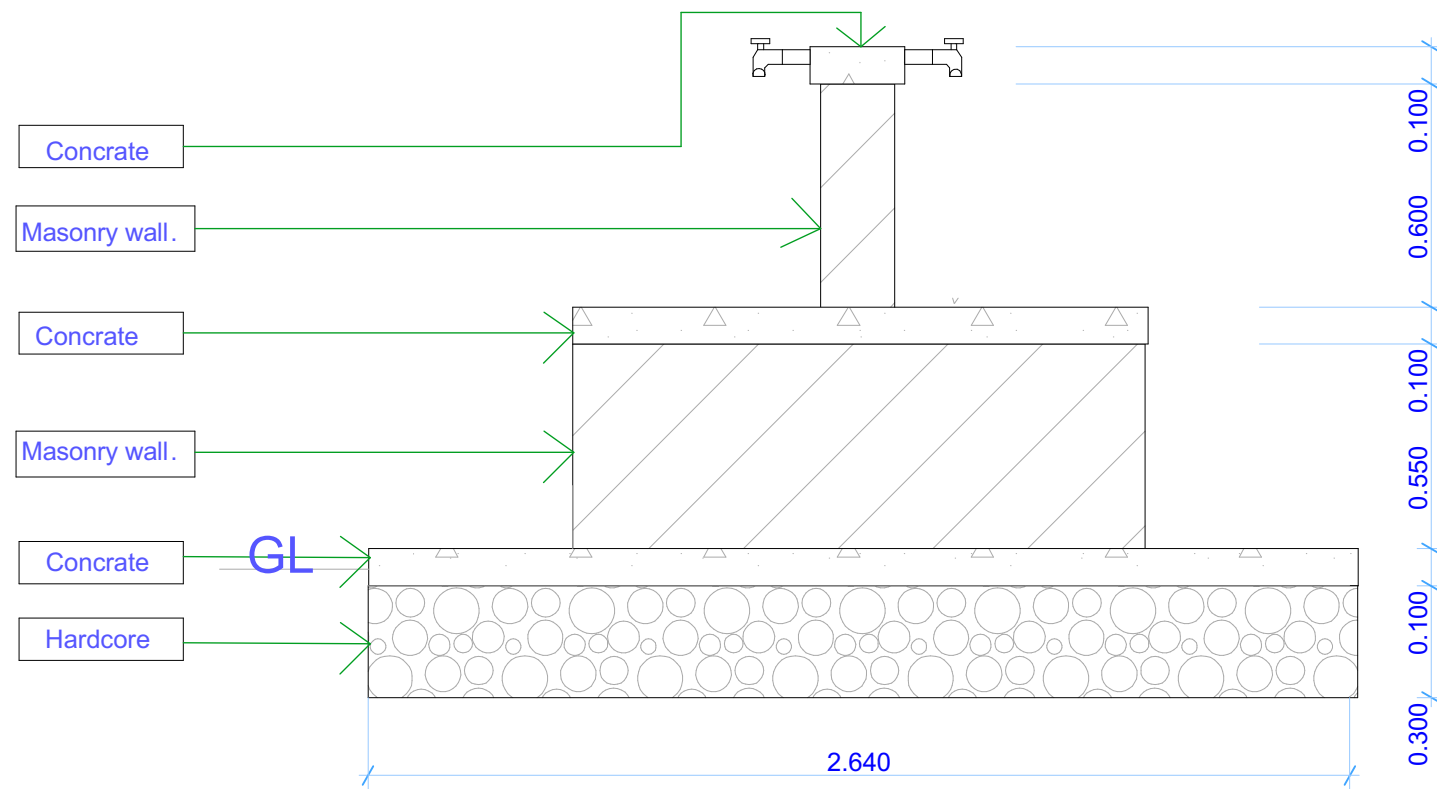
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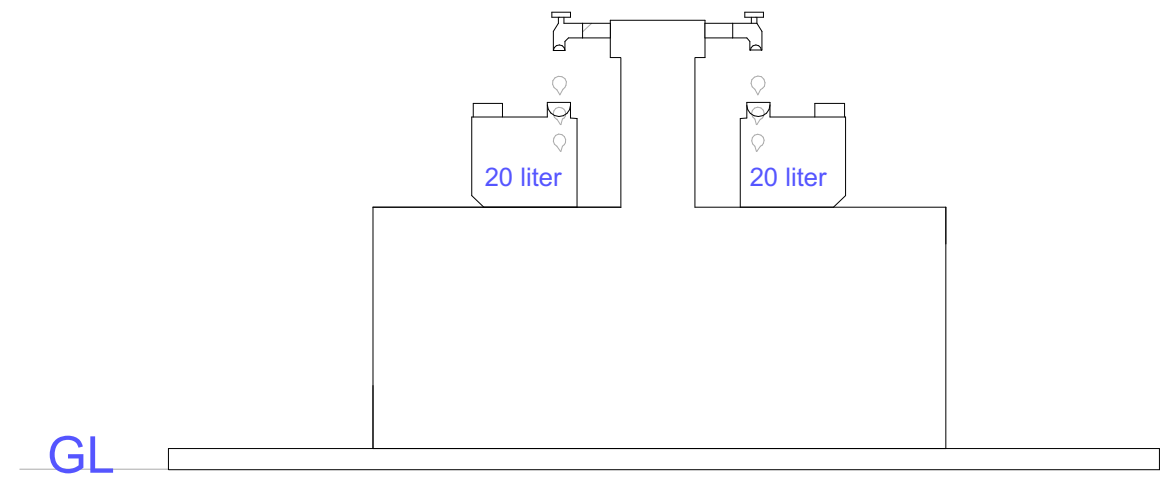
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**S.STRUCTURE
DETAILS**


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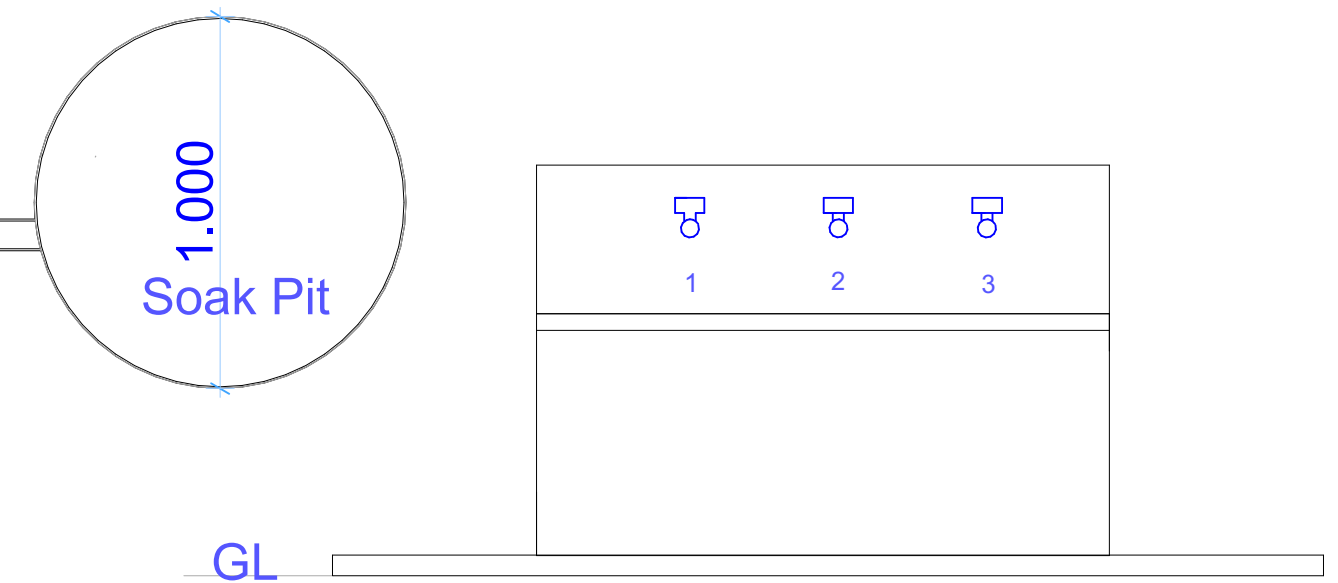
Section S-01



Side Elevation



Floor Plan

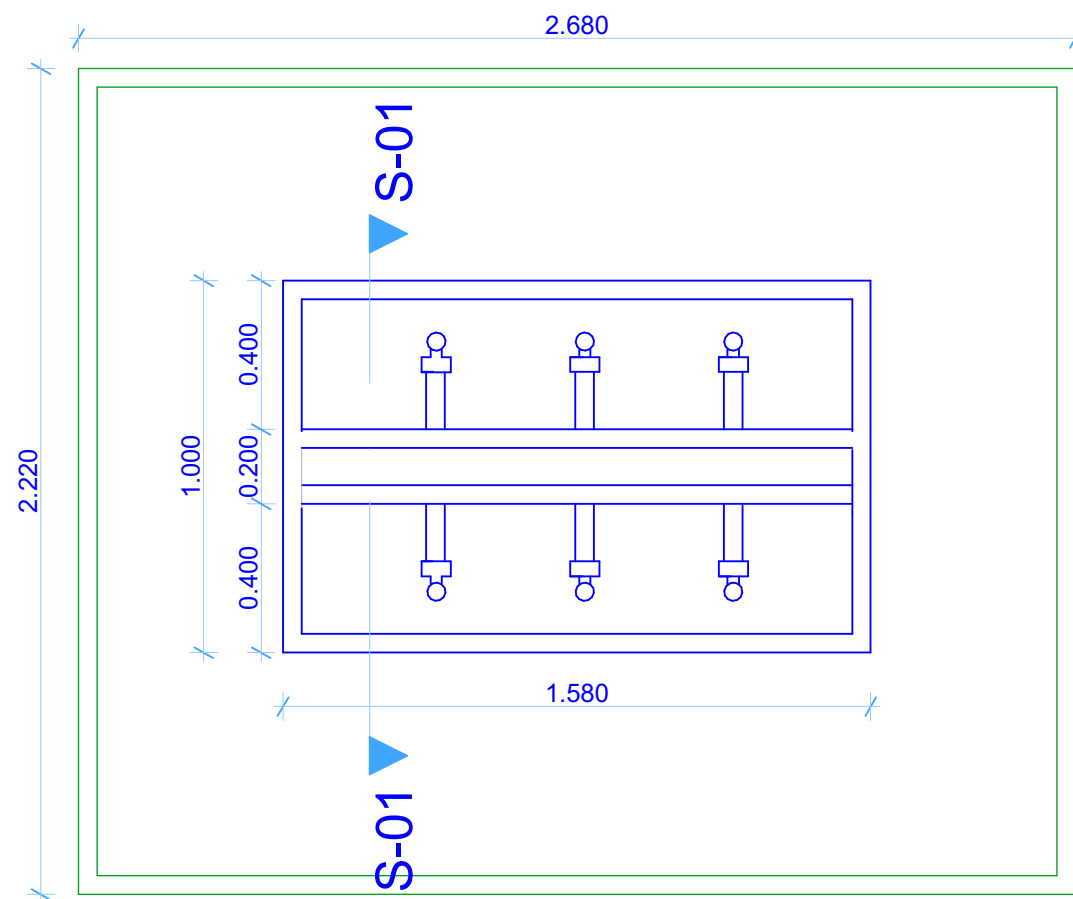

Front Elevation

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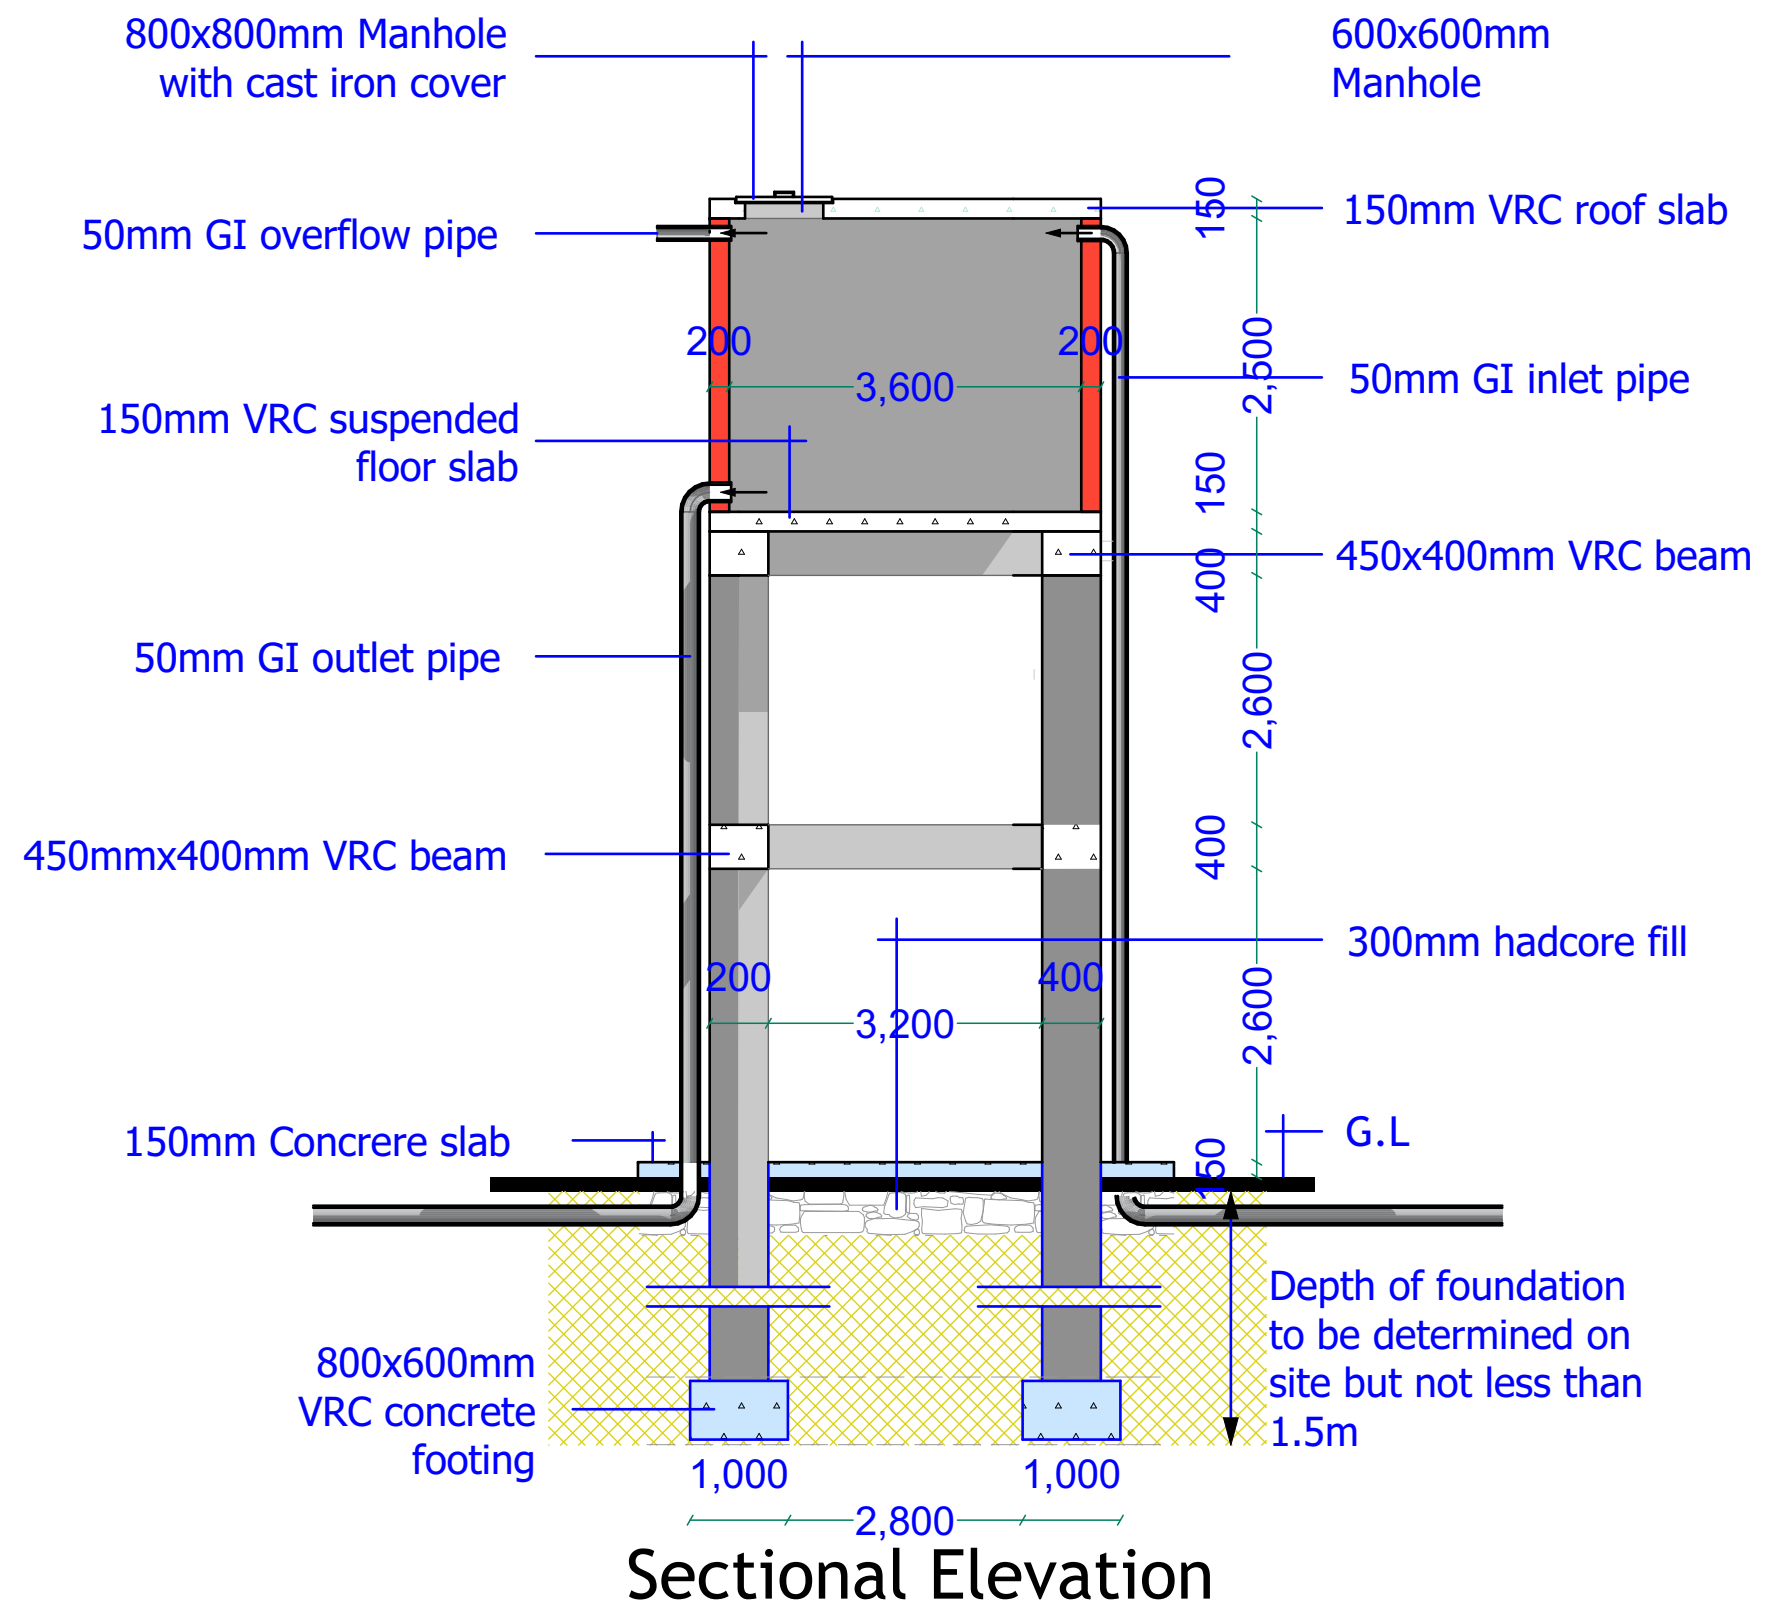
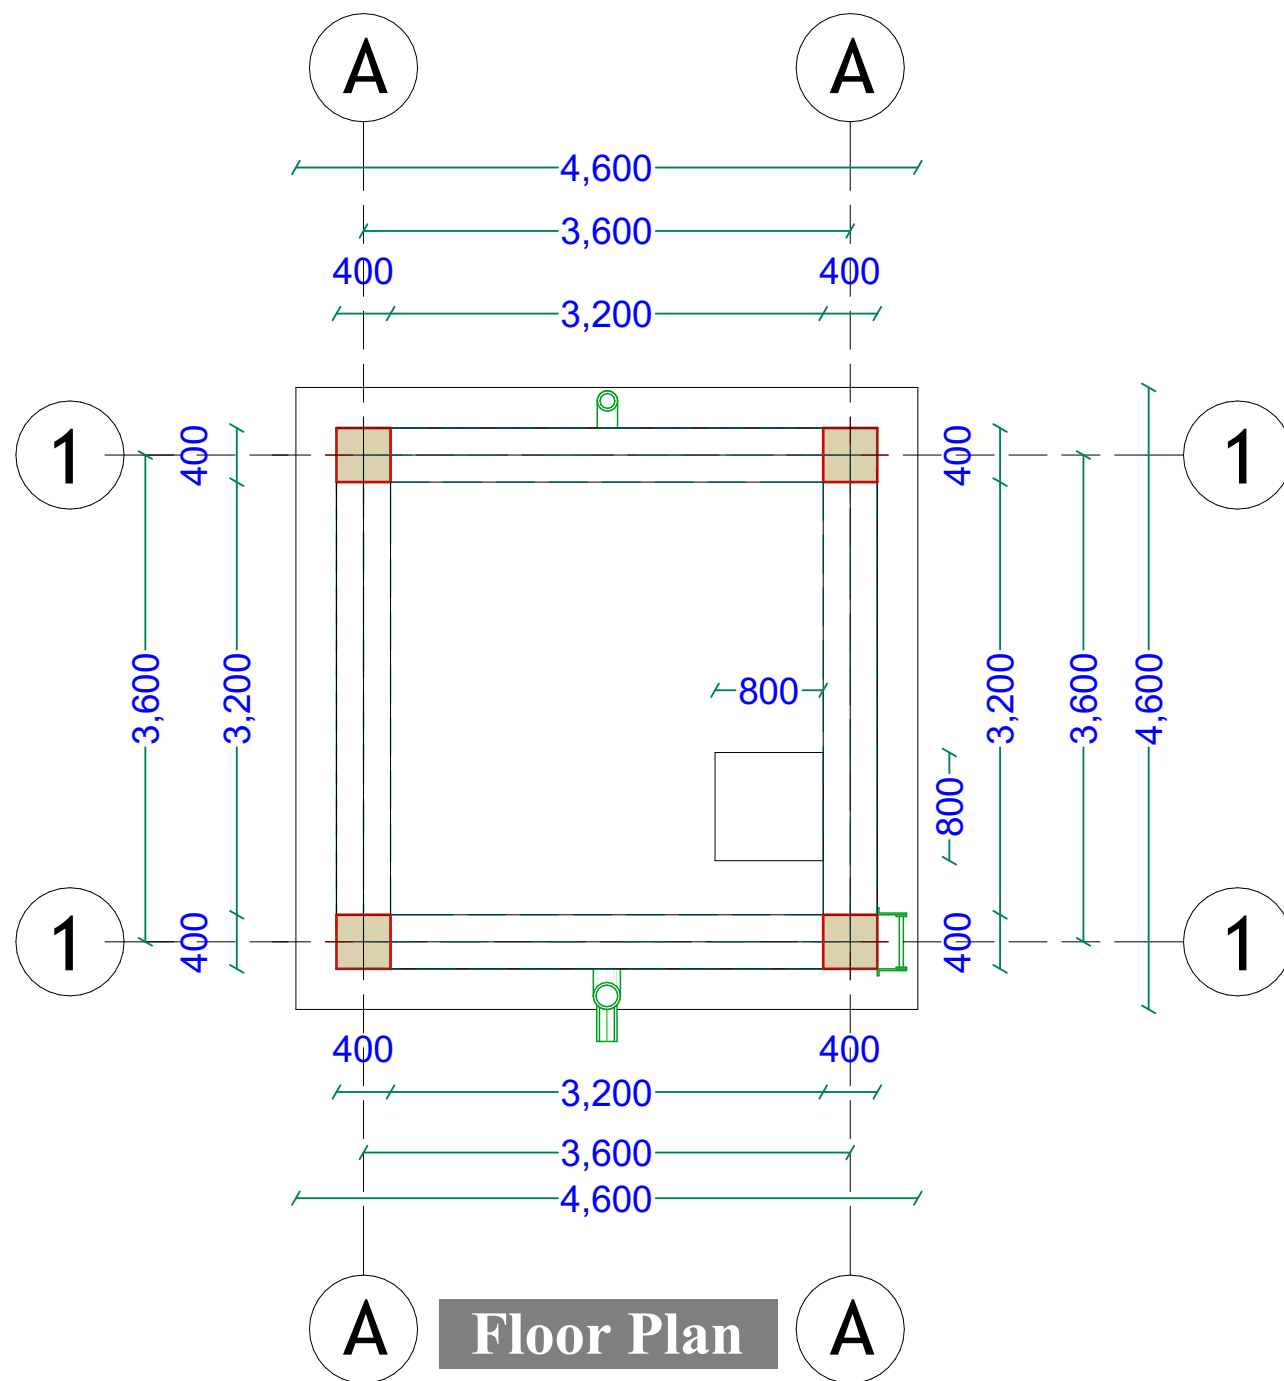
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DRAWING N^o:

PROJECT N^o:

WATER KIOSK

SHEET N^o:



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PROJECT

EXCAVATION OF SHALLOW WELLS

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DEPARTMENT

WATER SANITATION AND HYGIENE
WASH

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APPROVED BY:	


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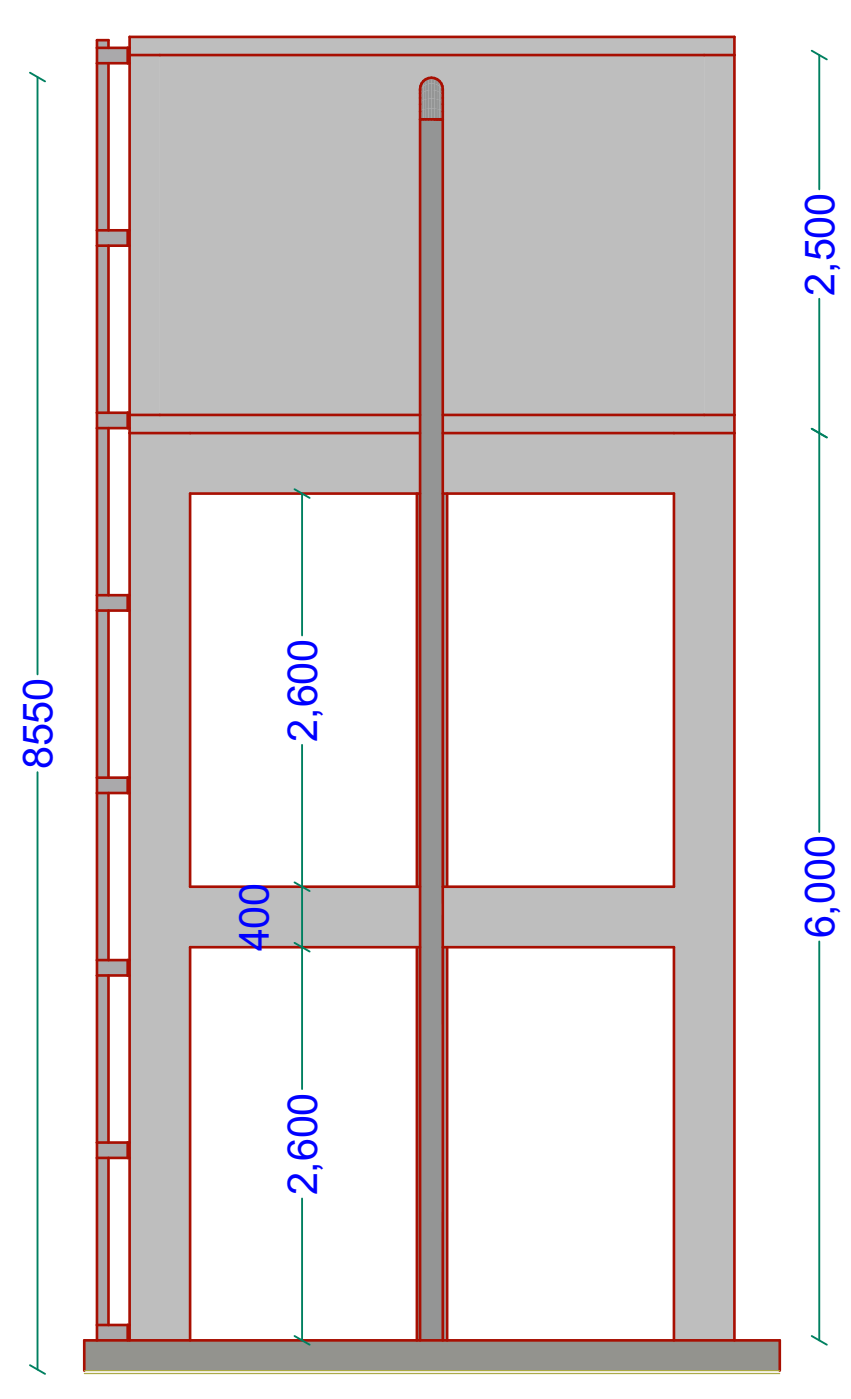
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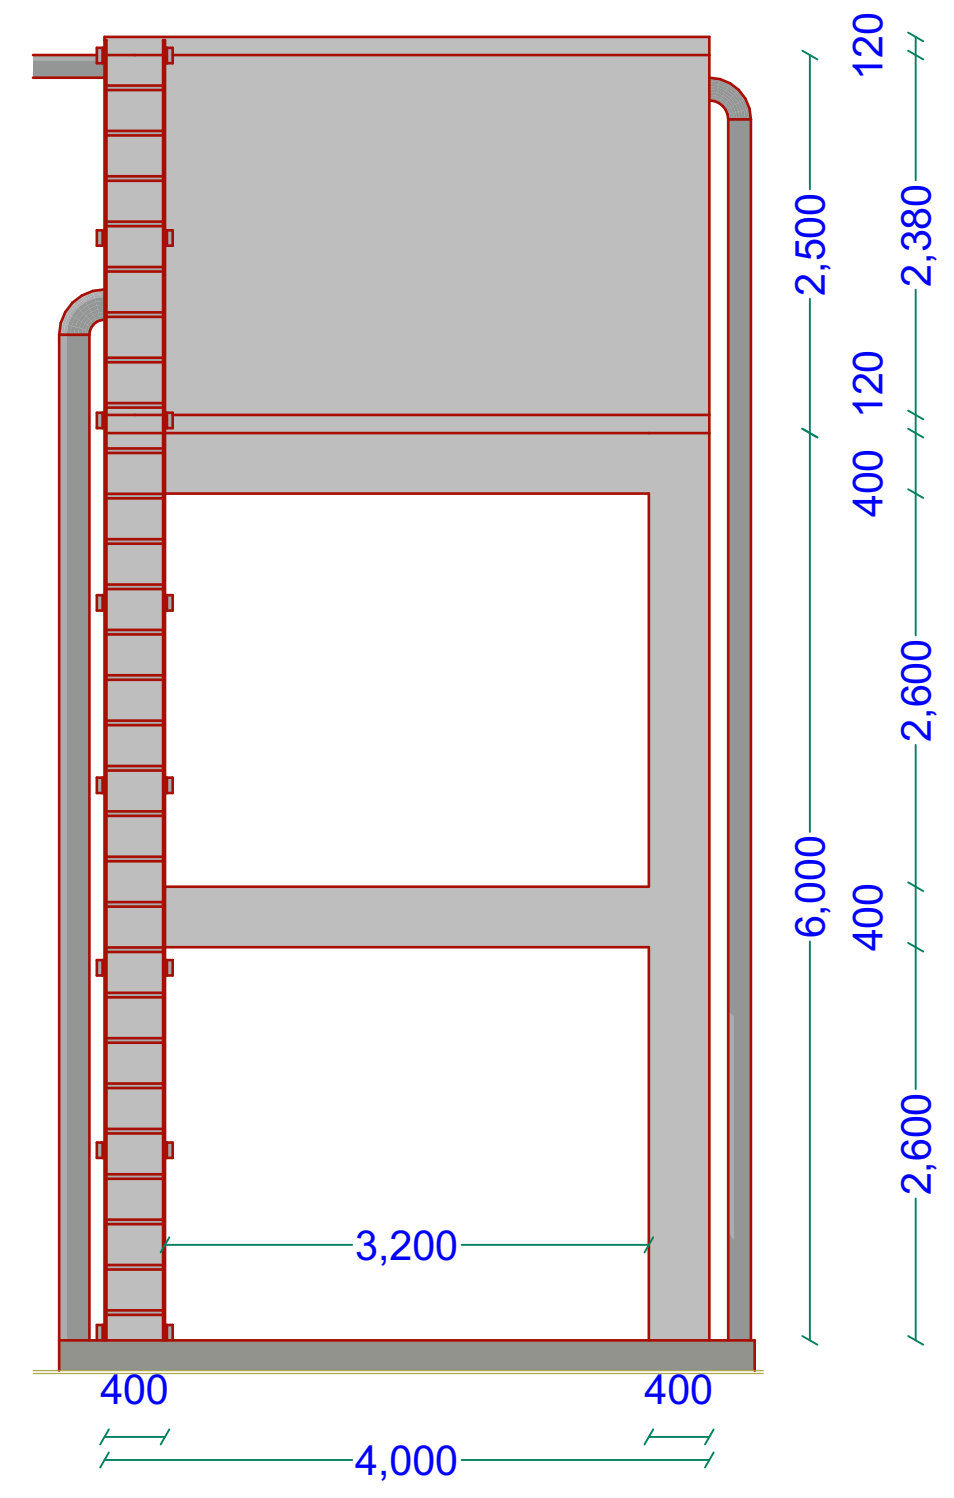
PROJECT N^o:



South Elevation



North Elevation

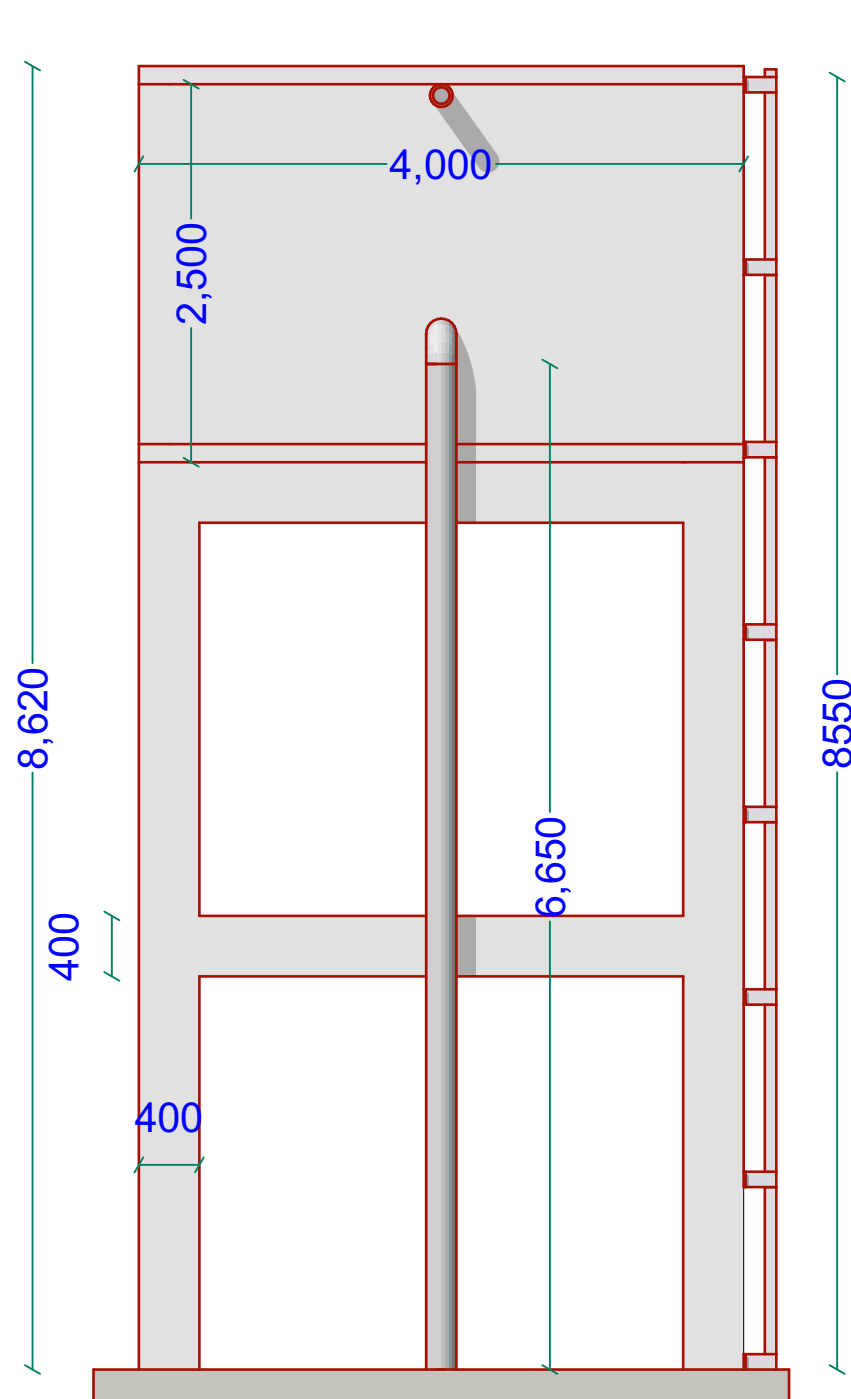

East Elevation

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PROJECT

EXCAVATION OF SHALLOW WELLS

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WATER SANITATION AND HYGIENE
WASH

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REVIEWED BY:	
APPROVED BY:	


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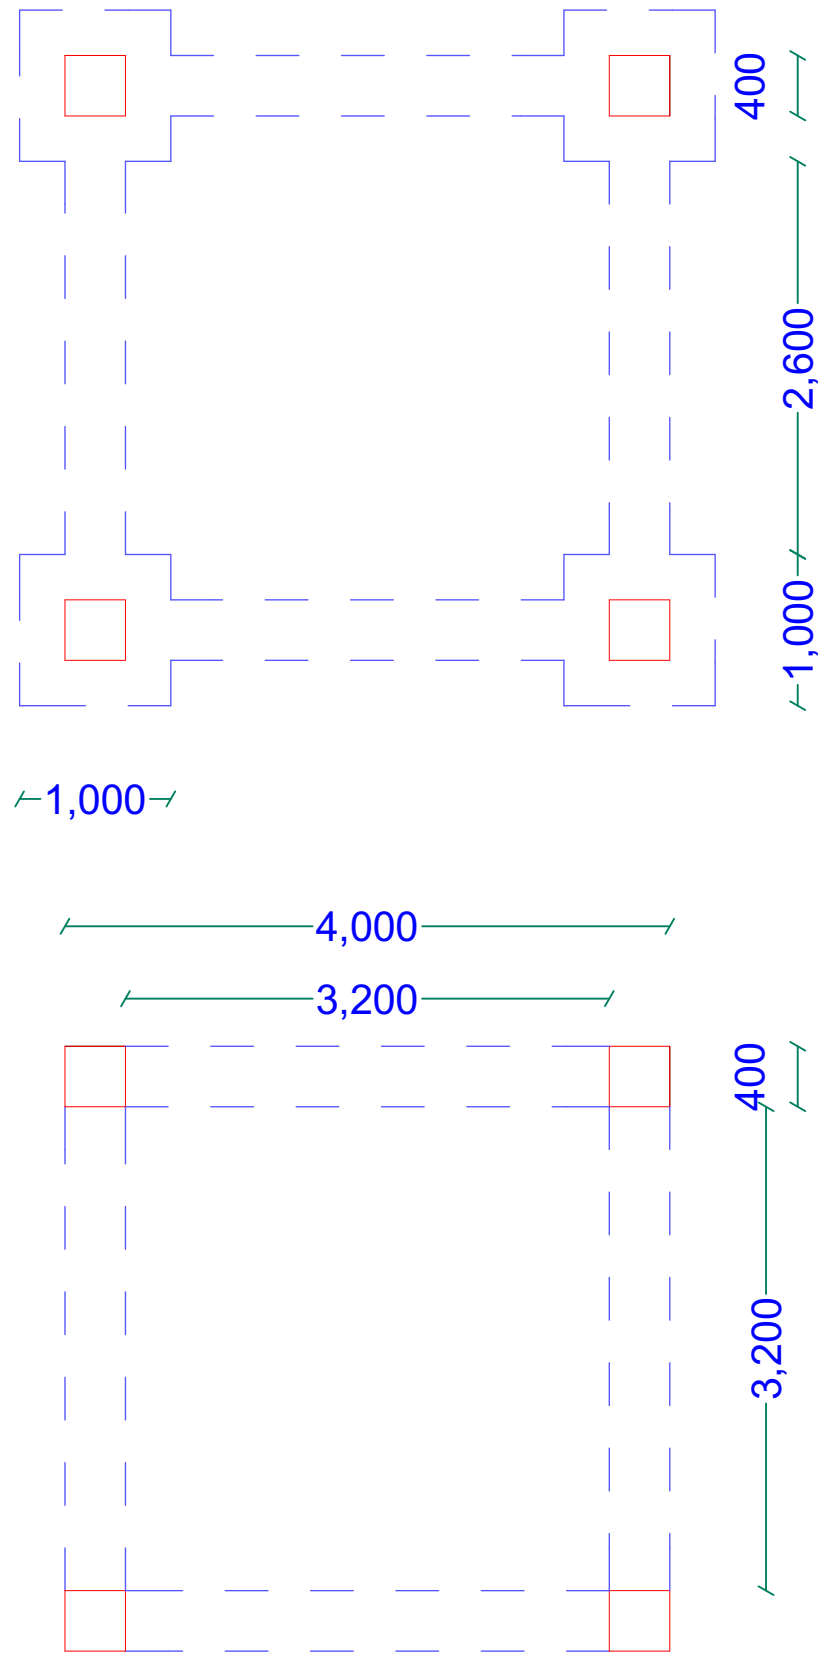
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ELEVATED TANK


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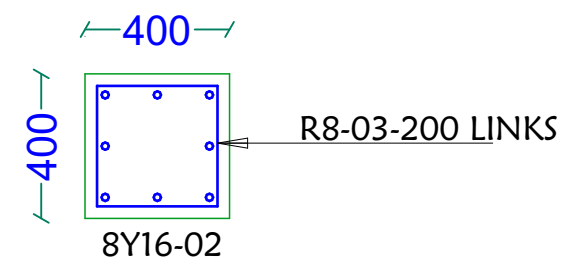
West Elevation




FOUNDATION LAYOUT

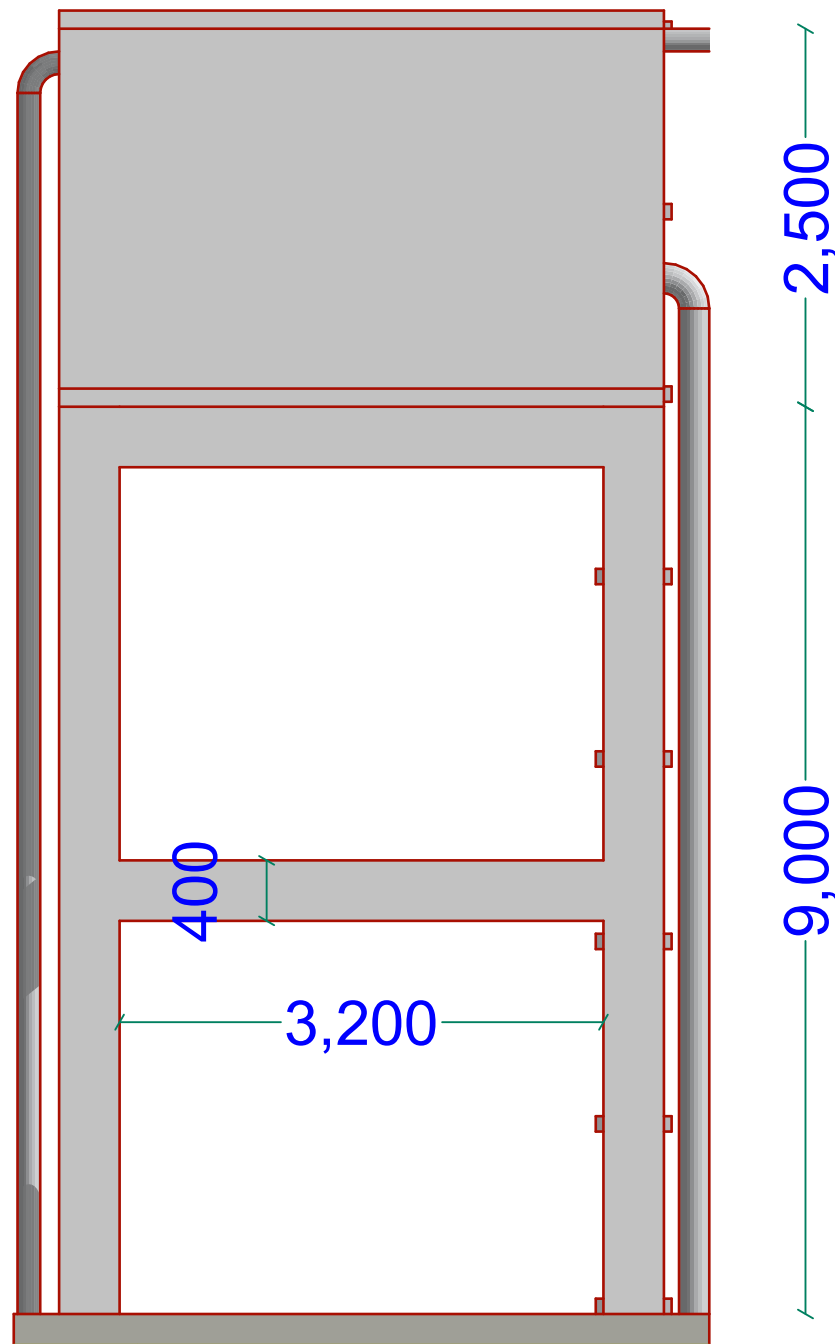


SECTION D-D
SCALE 1:25

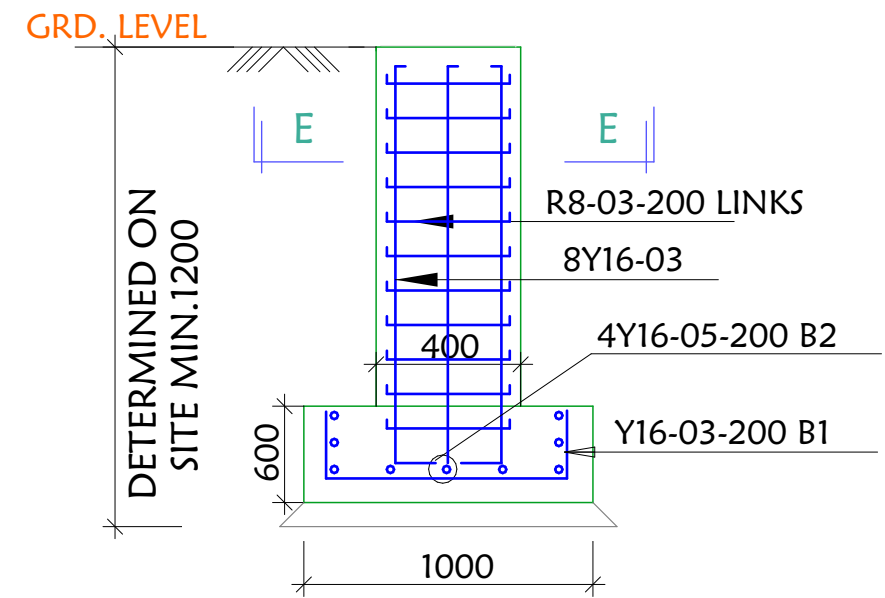

SECTION E-E (Column)
SCALE 1:25

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SCALE																		
DATE	JUNE 2020																	
DESIGNED BY:	ENG. Wanja.D																	
DRAWN BY:	ENG. Wanja.D																	
REVIEWED BY:																		
APPROVED BY:																		

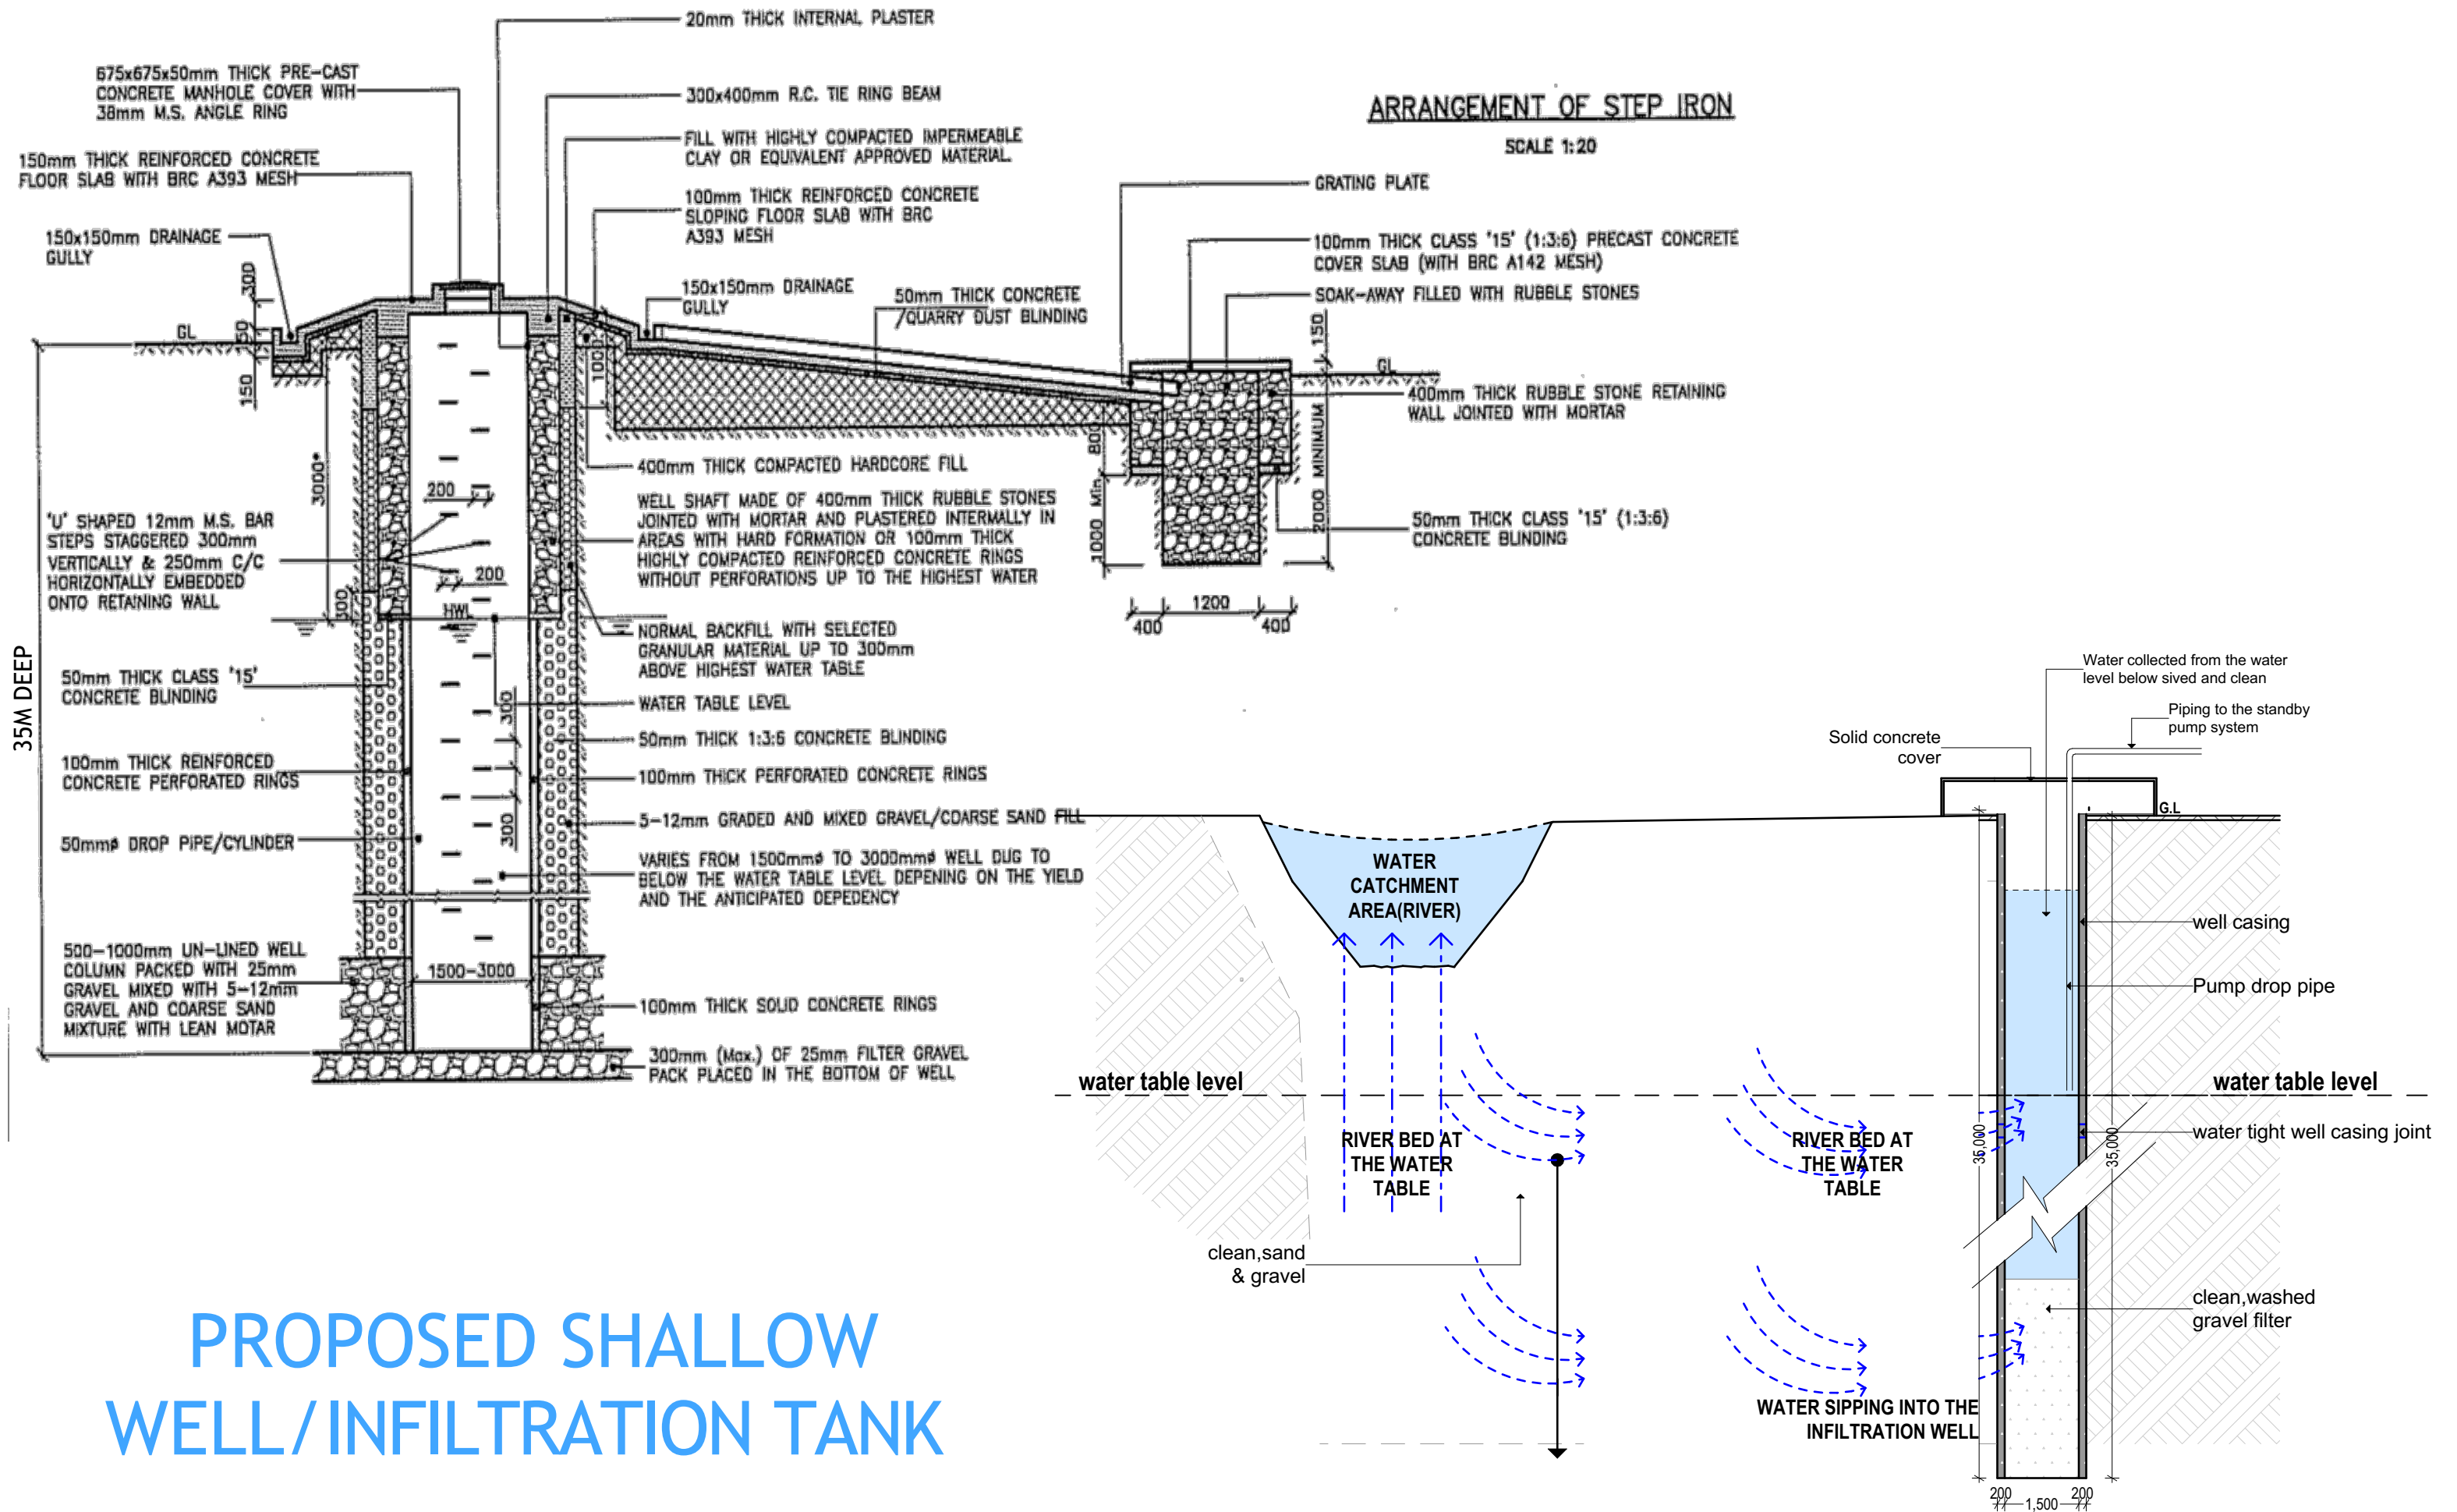

PROPOSED SHALLOW WELL/INFILTRATION TANK

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PROJECT

EXCAVATION OF SHALLOW WELLS

IMPLEMENTING AGENCY



DEPARTMENT

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WASH

SCALE	
DATE	JUNE 2020
DESIGNED BY:	ENG. Wanja.D
DRAWN BY:	ENG. Wanja.D
REVIEWED BY:	
APPROVED BY:	






DRAWING TITLE:

DRAWING N°:

PROJECT N°:

SHALLOW WELL

SHEET N°:

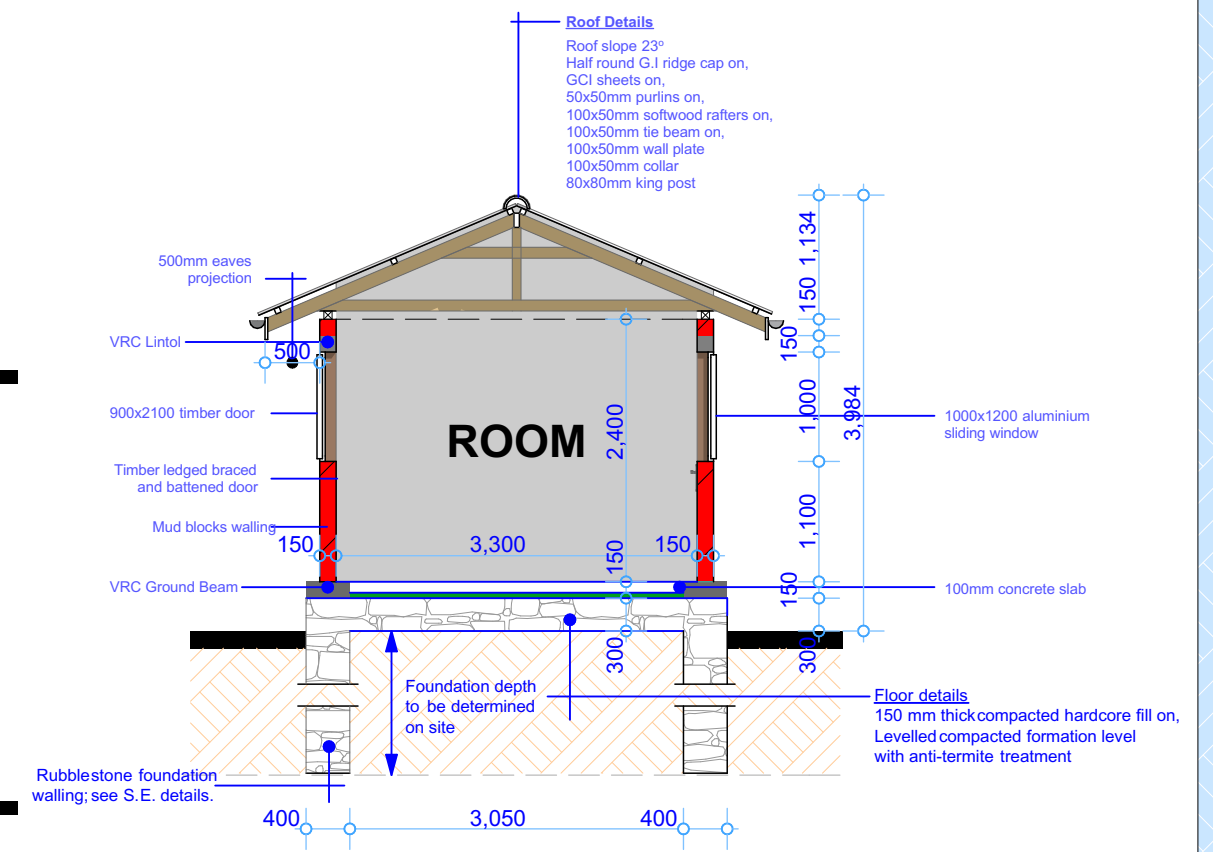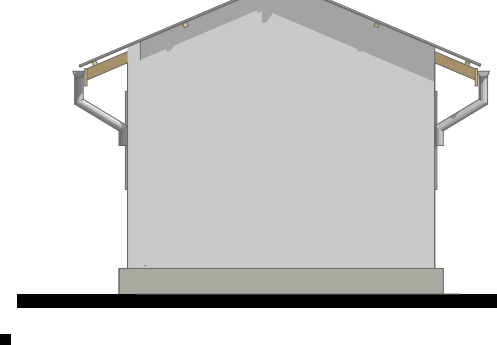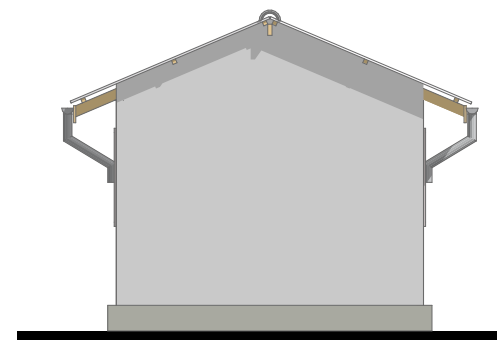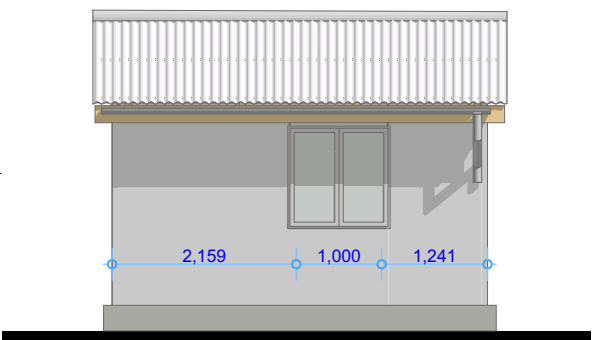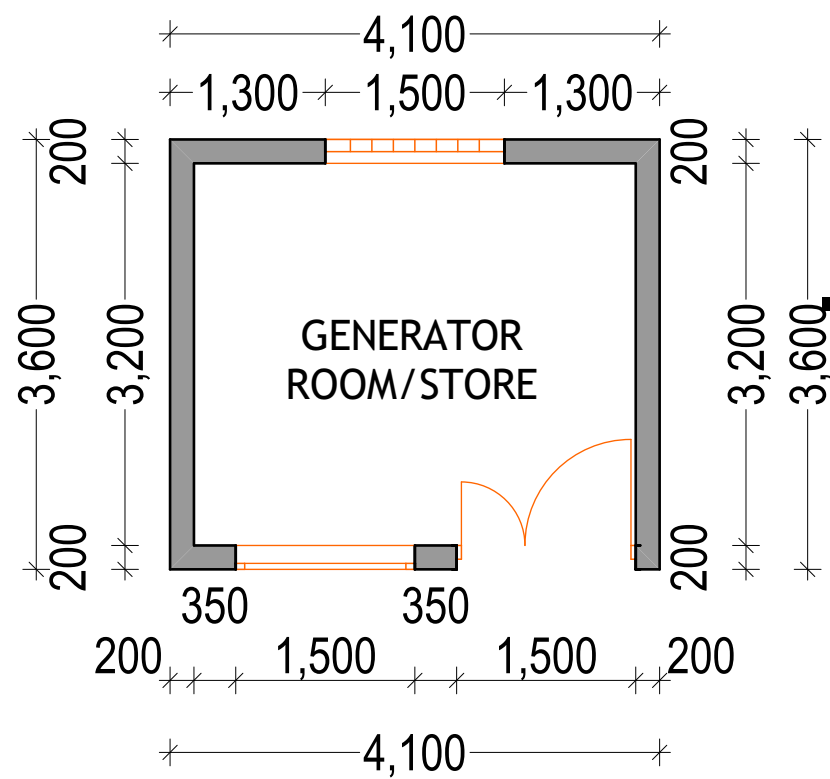

PROJECT
 PROPOSED
 REHABILITATION/CONSTRUCTION WORKS



LOCATION
WASH SUPPORTED
 ACTIVITIES IN SOMALIA





DESCRIPTION

REV.	DESCRIPTION	DATE

STATUS	NEW CONSTRUCTION
DATE	APRIL 2020
DESIGNED BY:	ENG. WANJA D.
DRAWN BY :	ENG. WANJA D.
REVIEWED BY:	
APPROVED BY:	DR. O. KHYARE

DRAWING TITLE:
 Details
DRAWING N°:
PROJECT N°:

SHEET N°:

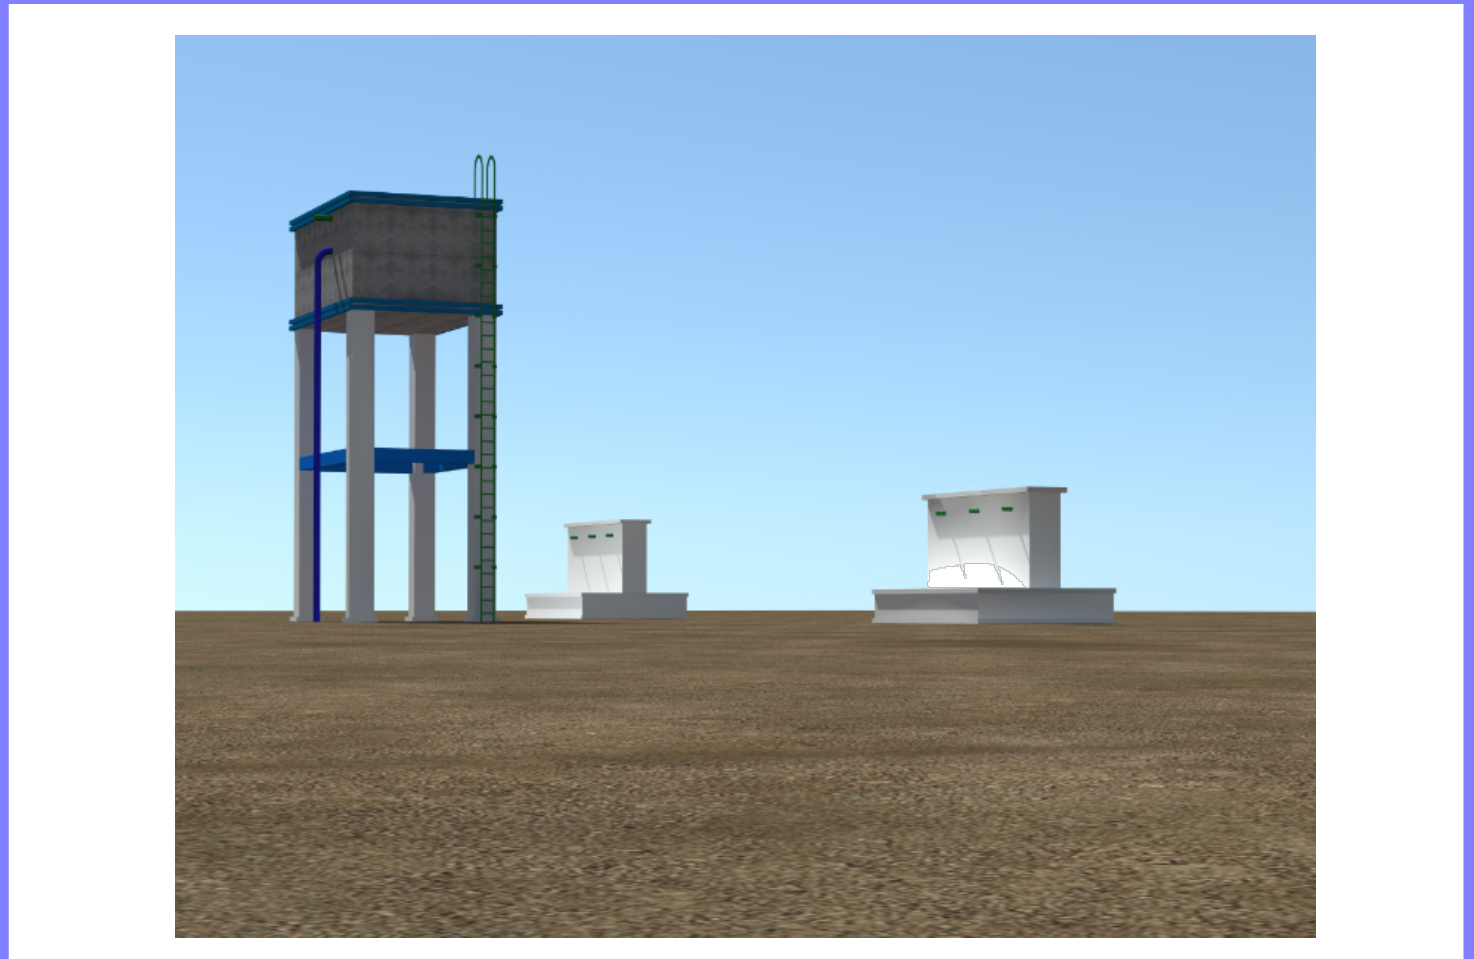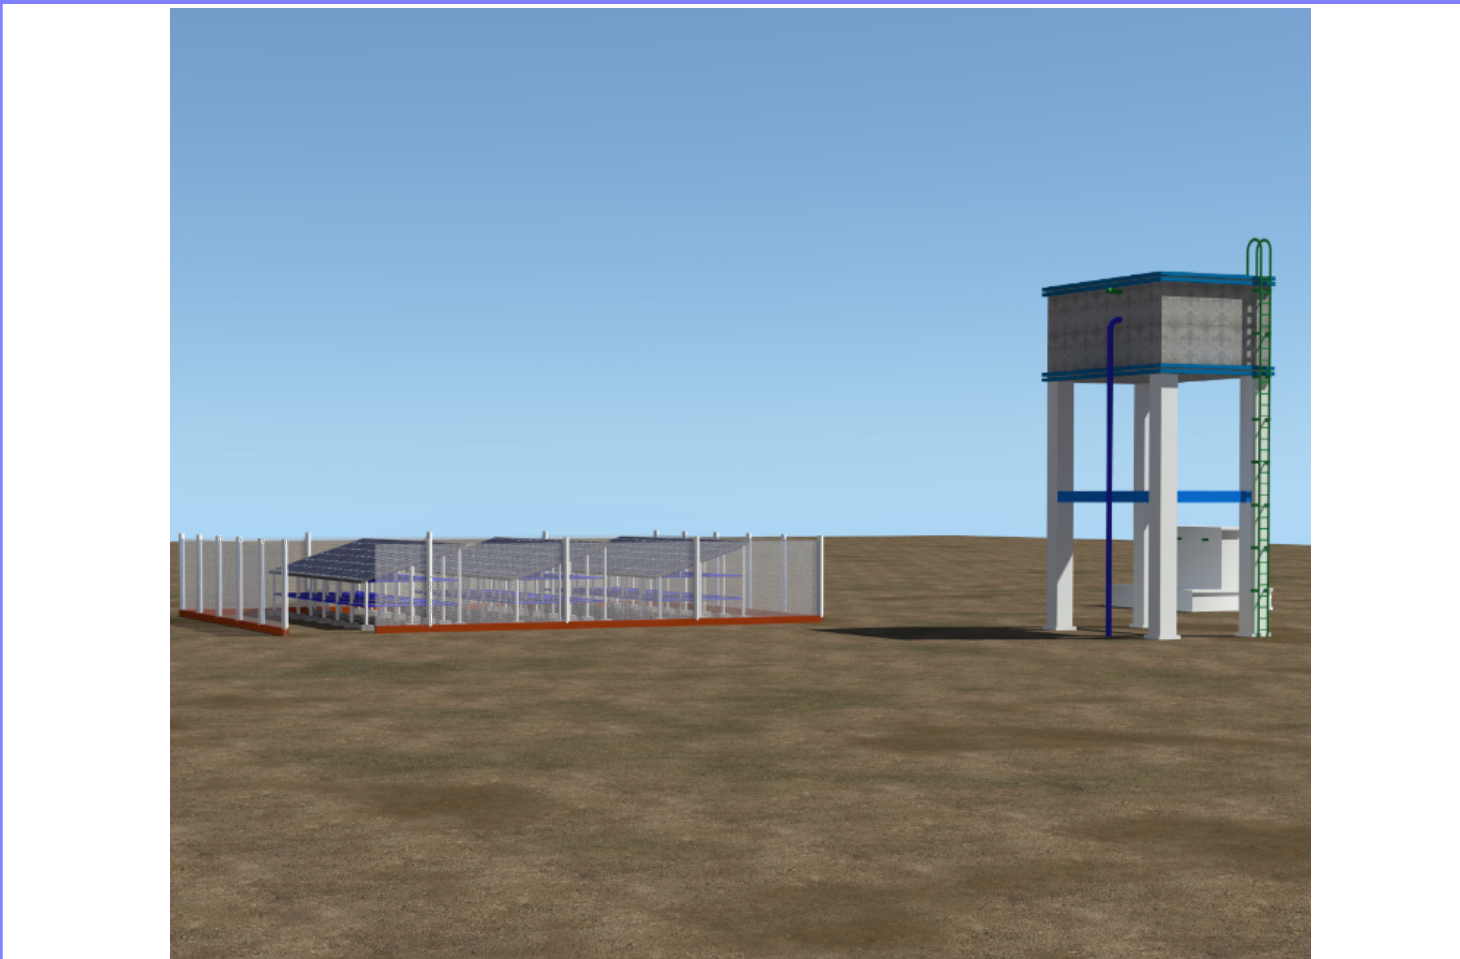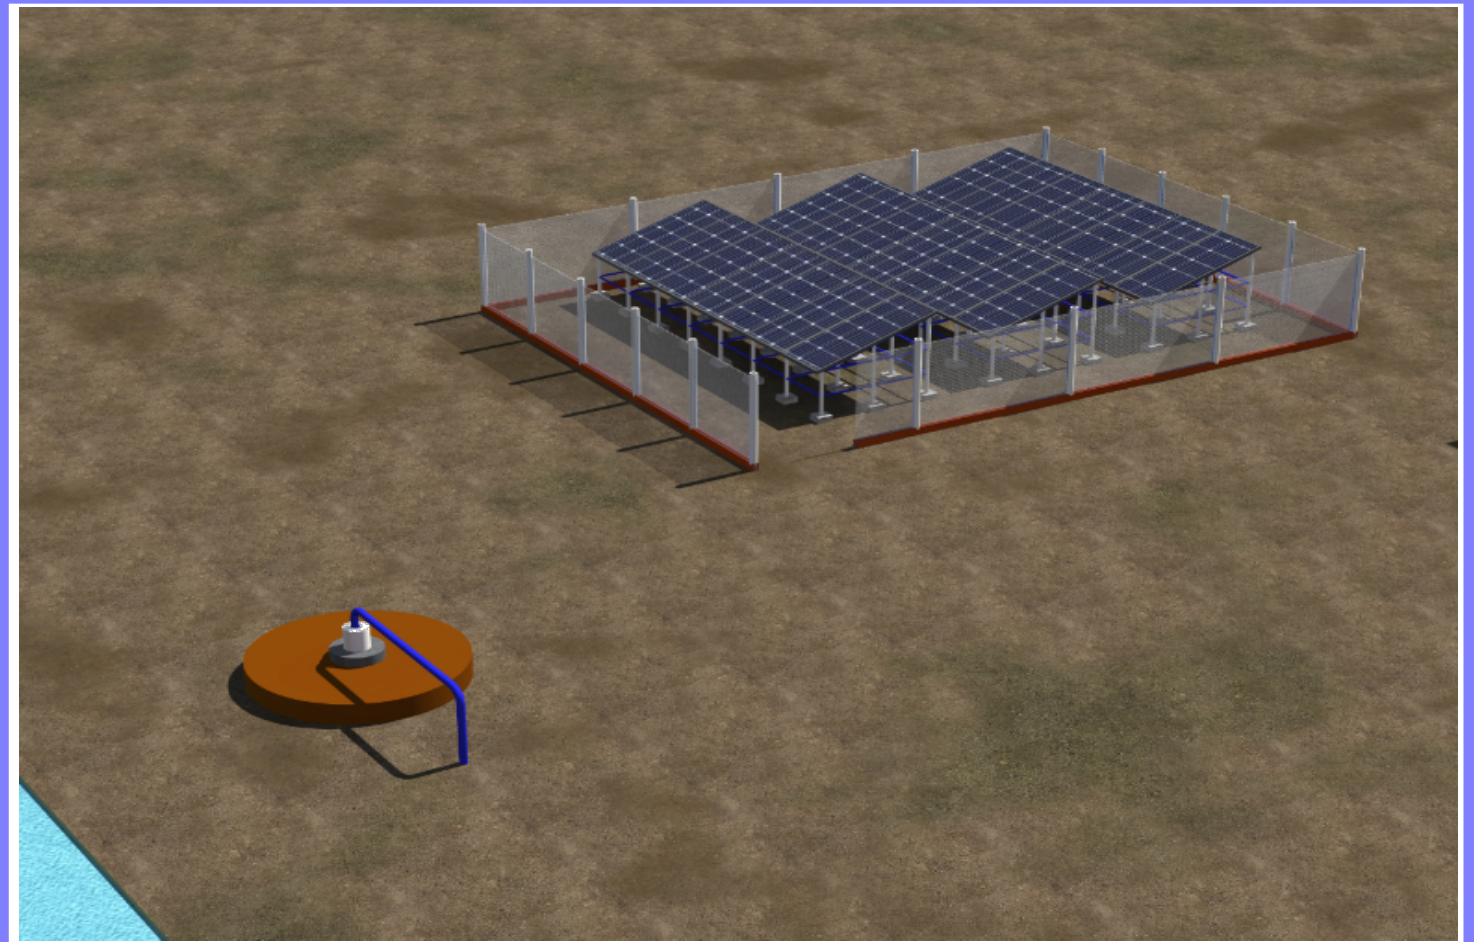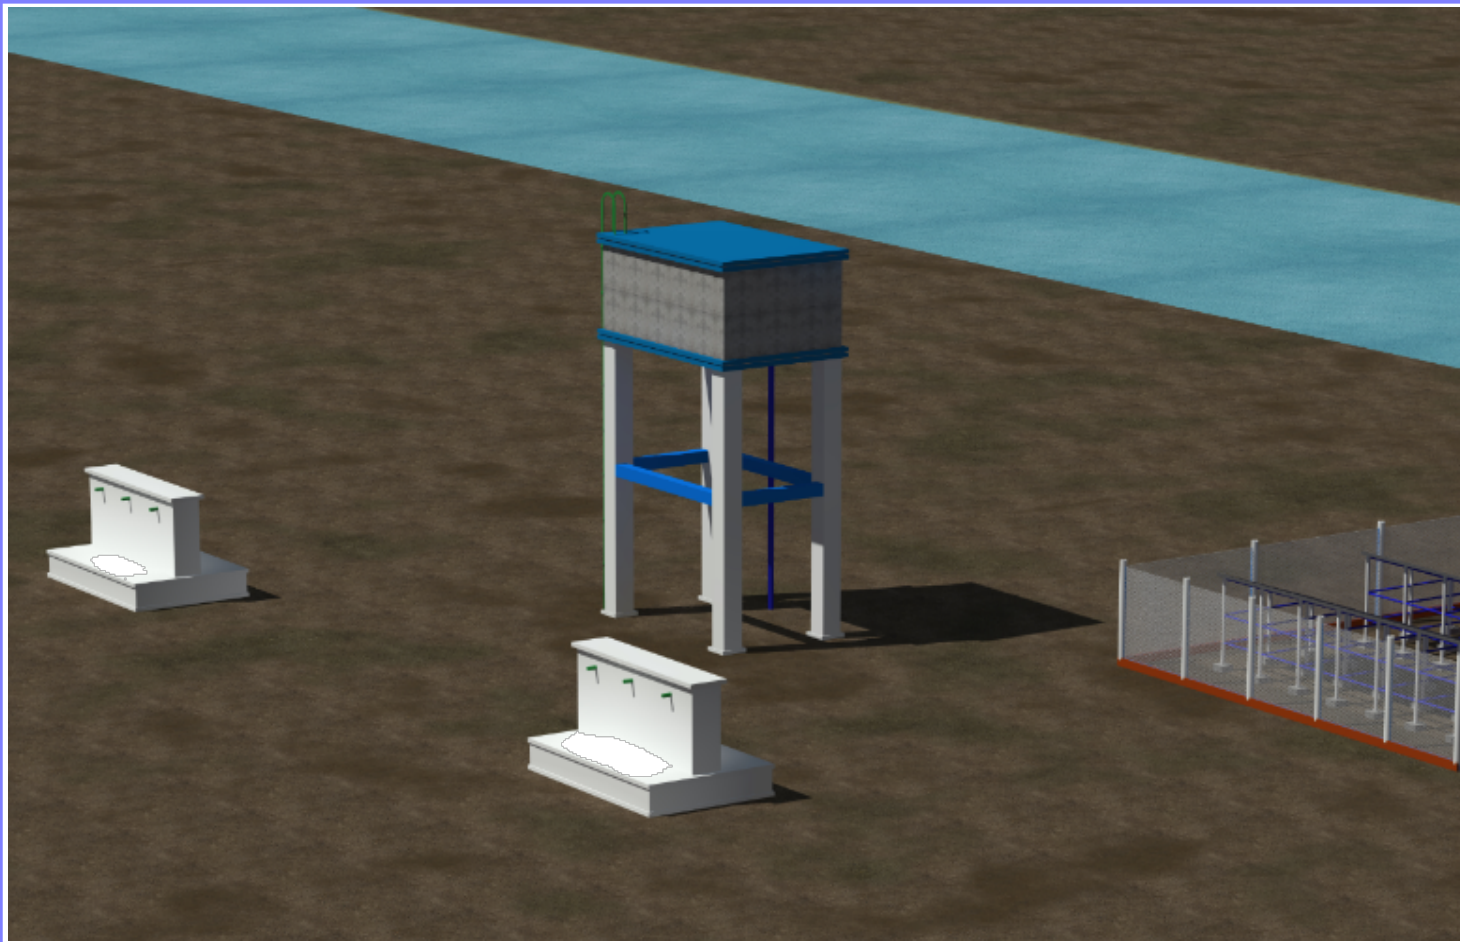

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DRAWN BY:	ENG. Wanja.D
REVIEWED BY:	
APPROVED BY:	

DRAWING TITLE:	
DRAWING N^o:	
PROJECT N^o:	

VIEWS
SHEET N ^o :

PS2-1800 C-SJ8-7

Solar Submersible Pump System for 4" wells

System Overview

Head	max. 40 m
Flow rate	max. 13 m ³ /h

Technical Data

Controller PS2-1800

- Controlling and monitoring
- Control inputs for dry running protection, remote control etc.
- Protected against reverse polarity, overload and overtemperature
- Integrated MPPT (Maximum Power Point Tracking)
- Battery operation: Integrated low voltage disconnect
- Integrated Sun Sensor

Power	max. 1,8 kW
Input voltage	max. 200 V
Optimum Vmp**	> 102 V
Motor current	max. 14 A
Efficiency	max. 98 %
Ambient temp.	-40...50 °C
Enclosure class	IP68

Motor ECDRIVE 1200-C / ECDRIVE 1800-C

- Maintenance-free brushless DC motor
- Water filled
- Premium materials, stainless steel: AISI 304/316
- No electronics in the motor

Rated power	1,7 kW
Efficiency	max. 92 %
Motor speed	900...3 300 rpm
Insulation class	F
Enclosure class	IP68
Submersion	max. 150 m

Pump End PE C-SJ8-7

- Non-return valve
- Premium materials, stainless steel: AISI 304
- Optional: dry running protection
- Centrifugal pump

Pump Unit PU1800 C-SJ8-7 (Motor, Pump End)

Borehole diameter	min. 4,0 in
Water temperature	max. 50 °C

Standards



2006/42/EC, 2004/108/EC, 2006/95/EC

IEC/EN 61702:1995

The logos shown reflect the approvals that have been granted for this product family. Products are ordered and supplied with the approvals specific to the market requirements.

**Vmp: MPP-voltage under Standard Test Conditions (STC): 1000 W/m² solar irradiance, 25 °C cell temperature




PS2-1800 C-SJ8-7

Solar Submersible Pump System for 4" wells

Pump Chart


V_{mp}* > 102 V

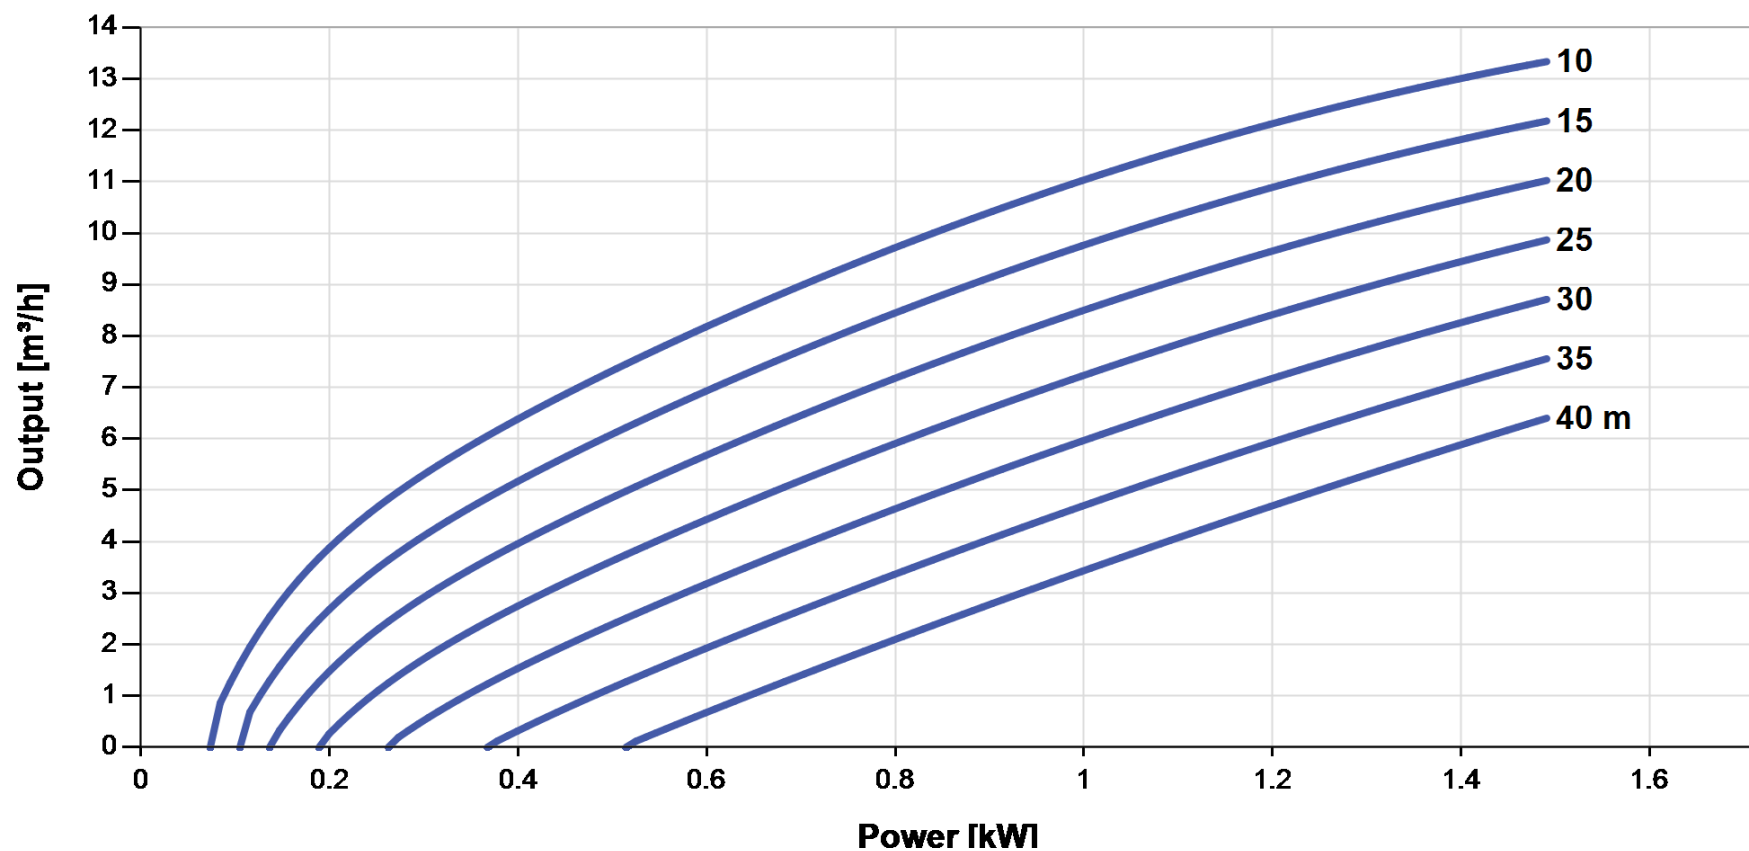

Dimensions and Weights


Controller

H1 = 352 mm
 H2 = 333 mm
 W1 = 207 mm
 W2 = 170 mm
 W3 = 164 mm
 D1 = 124 mm

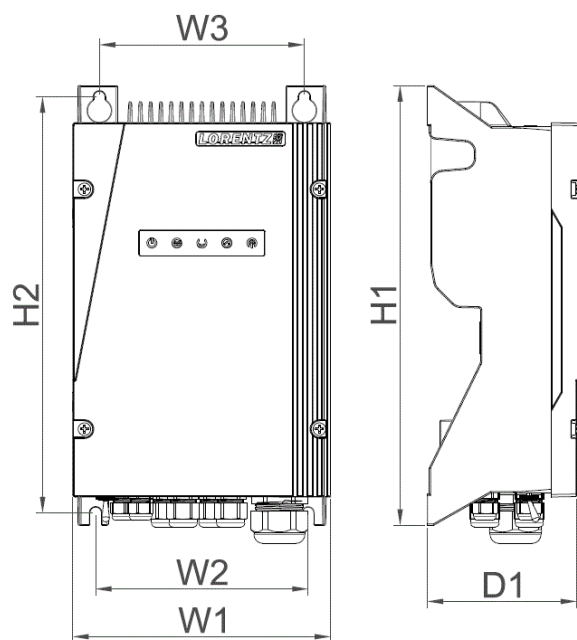

Pump Unit

A = 684 mm
 B = 185 mm
 C = 499 mm
 D = 96 mm
 E = 98 mm
 S = 2 in

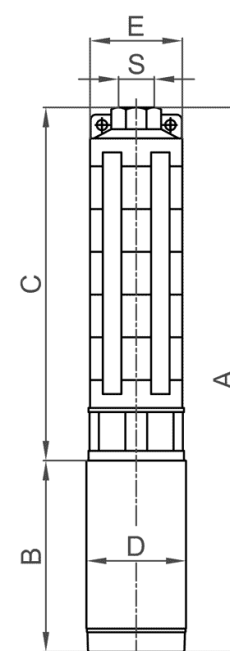

	Net weight
Controller	6,0 kg
Pump Unit	14 kg
Motor	7,0 kg
Pump End	6,5 kg

*V_{mp}: MPP-voltage under Standard Test Conditions (STC): 1000 W/m² solar irradiance, 25 °C cell temperature

